
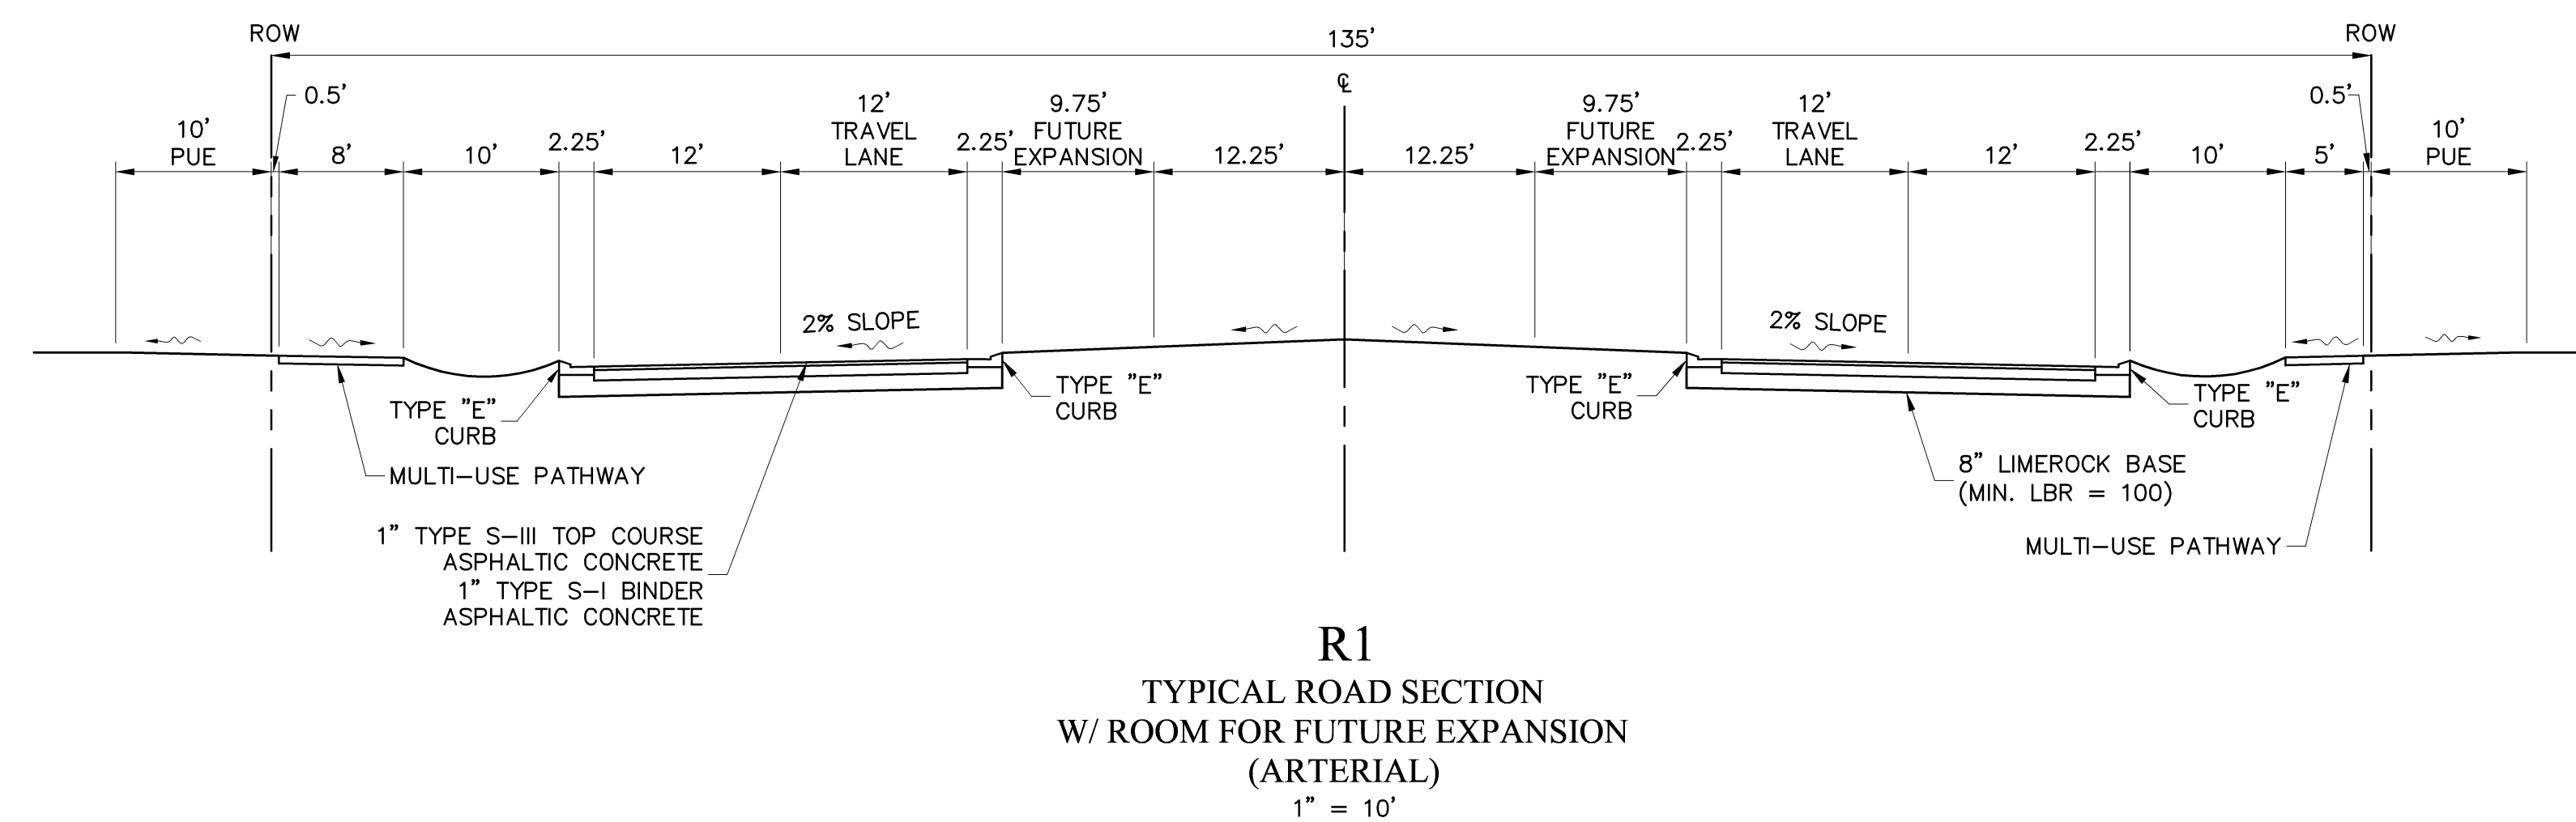
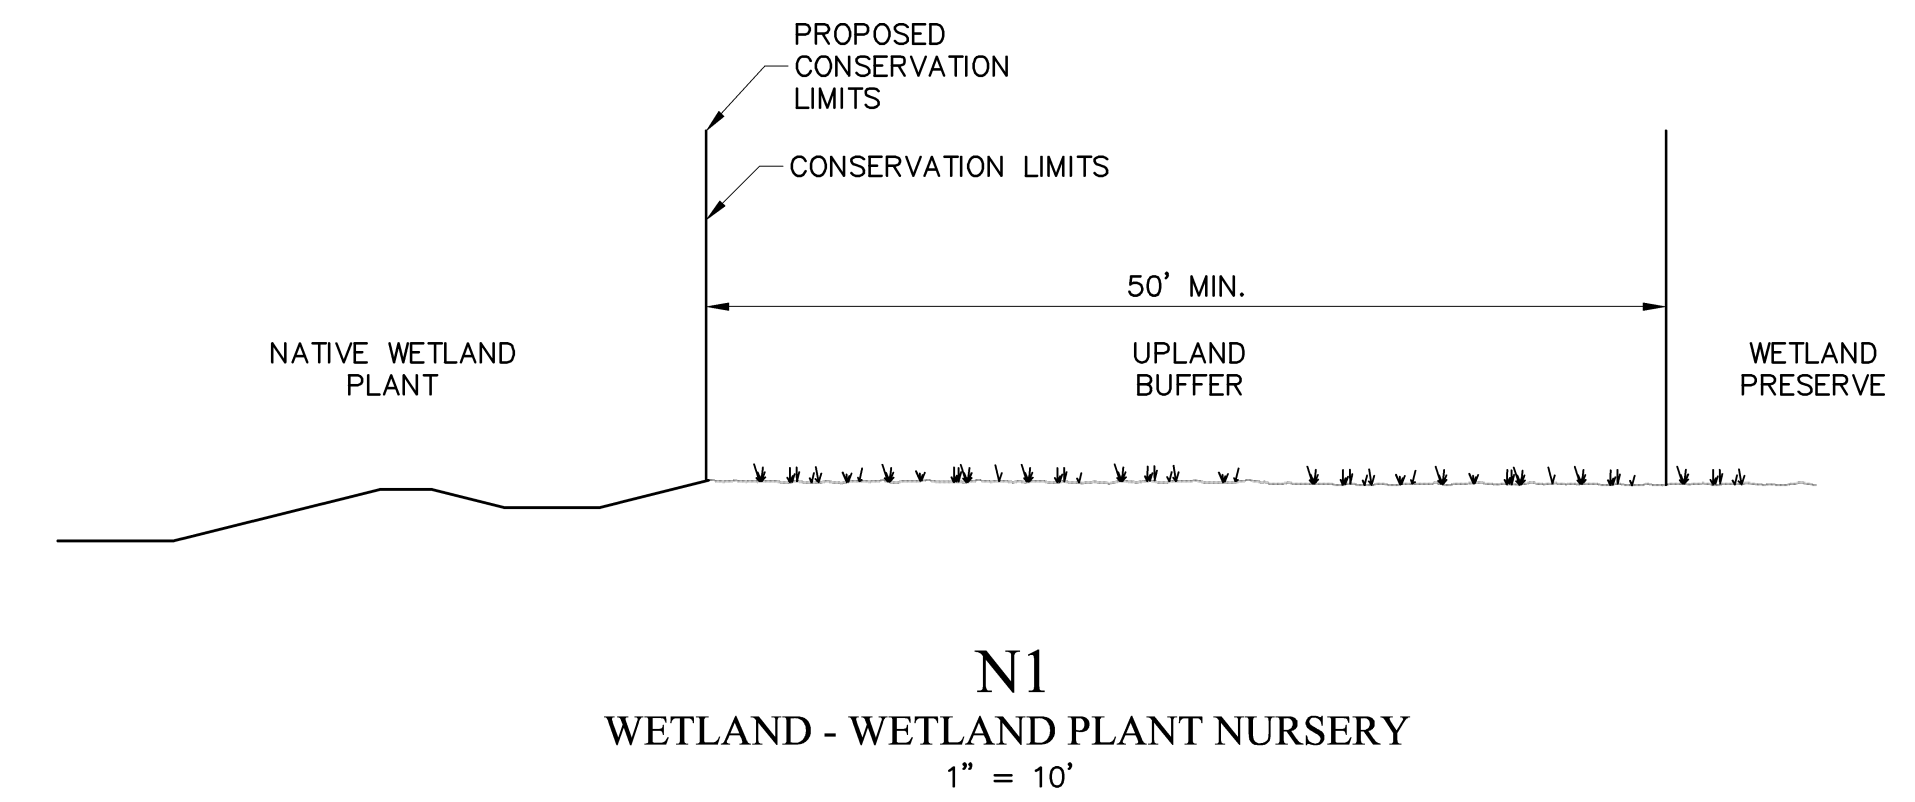
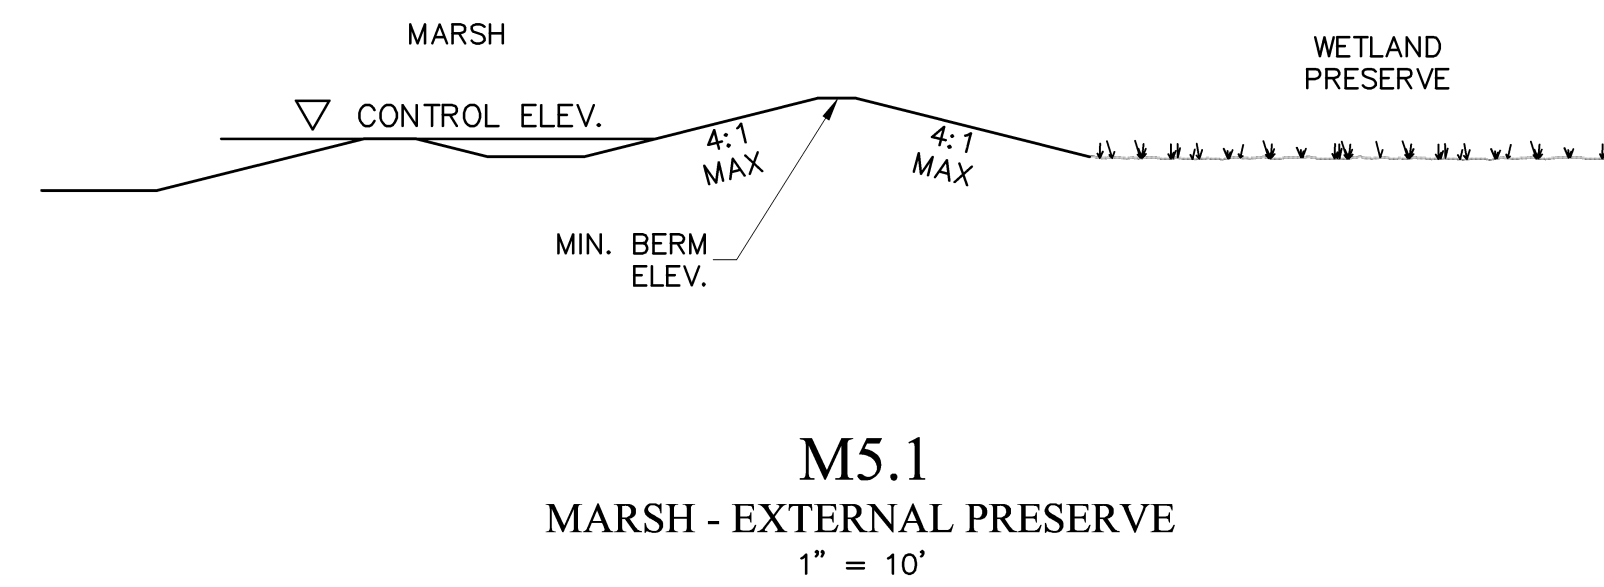
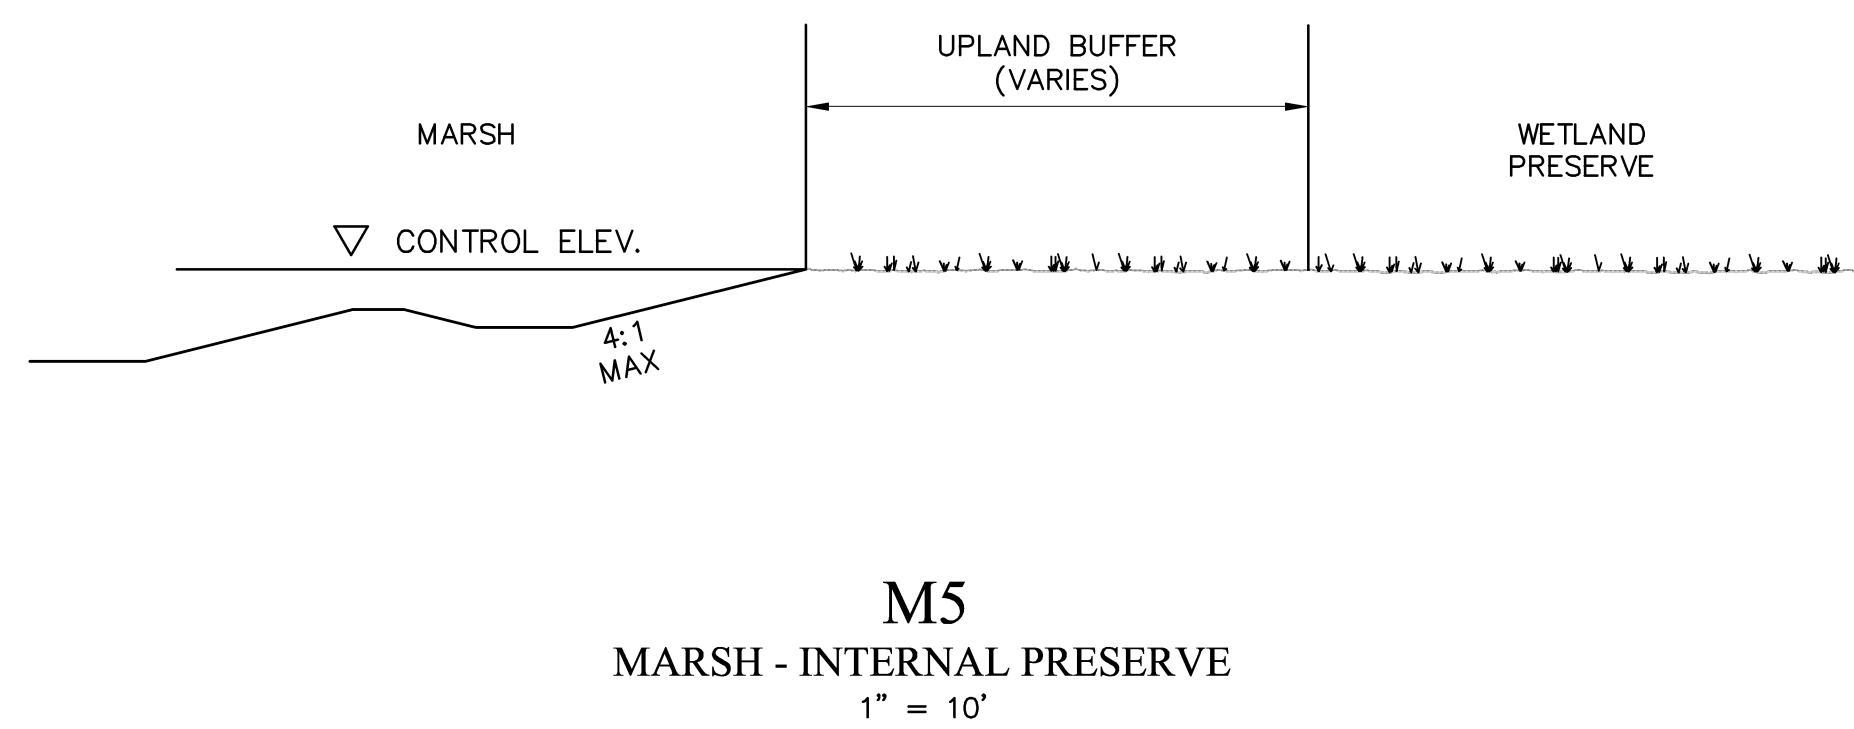
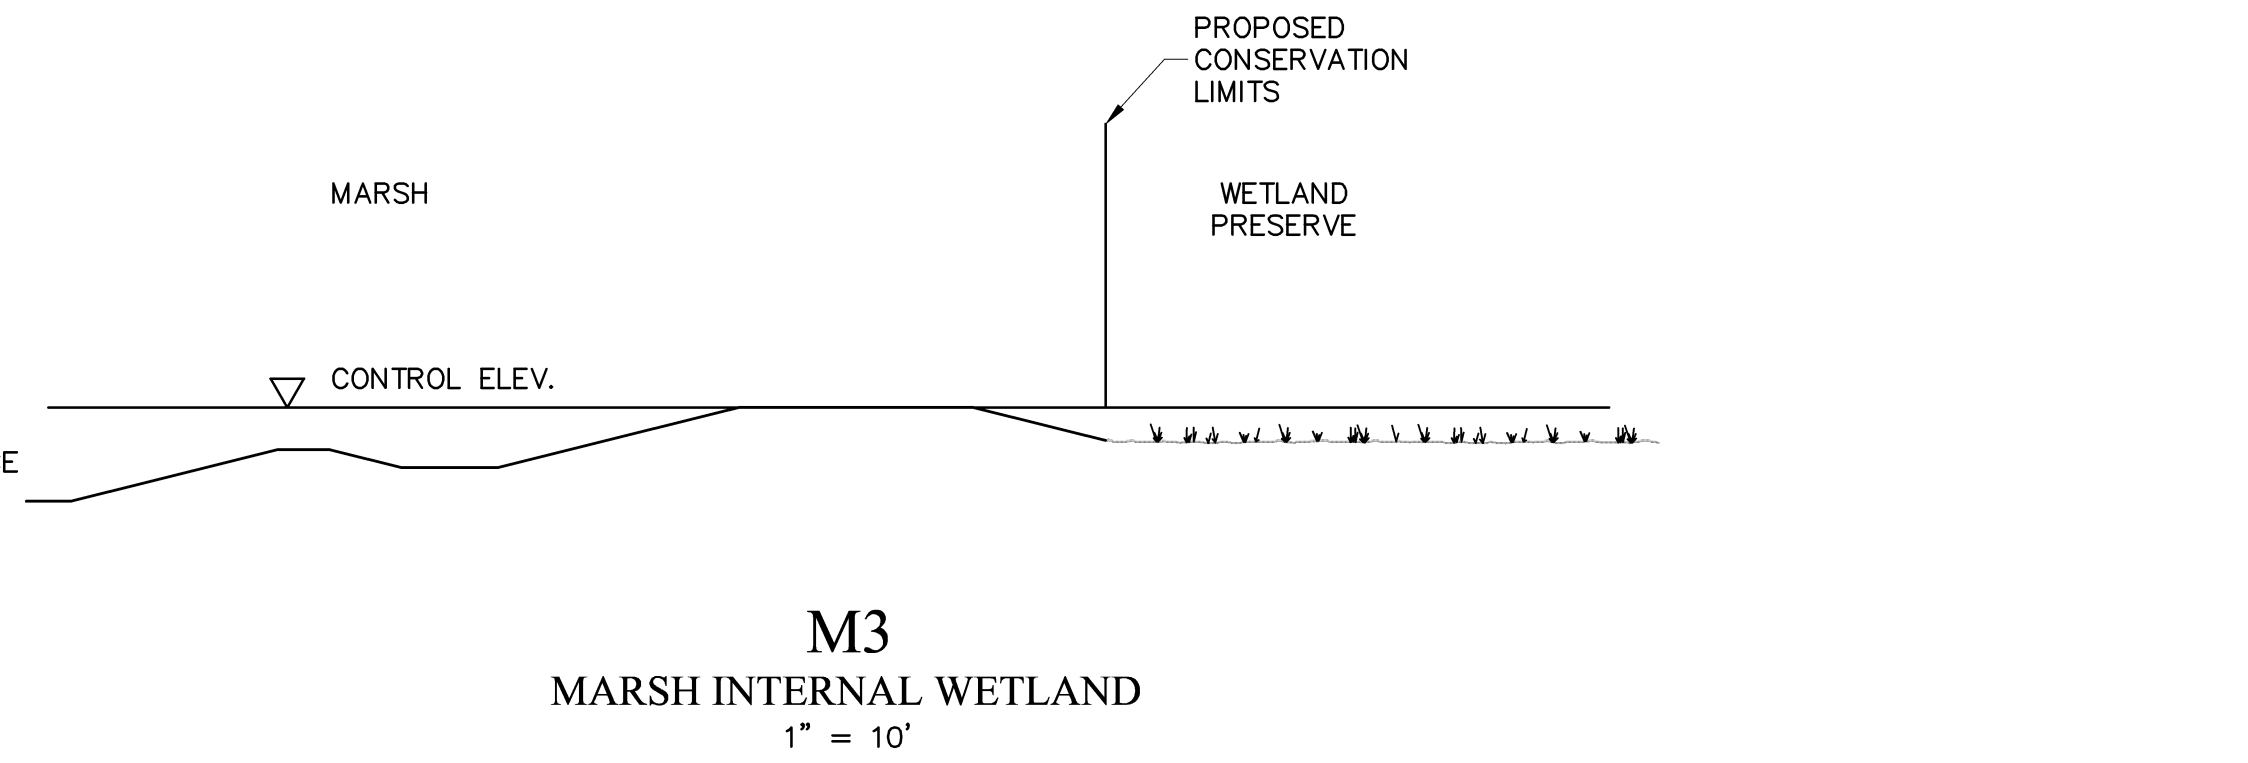
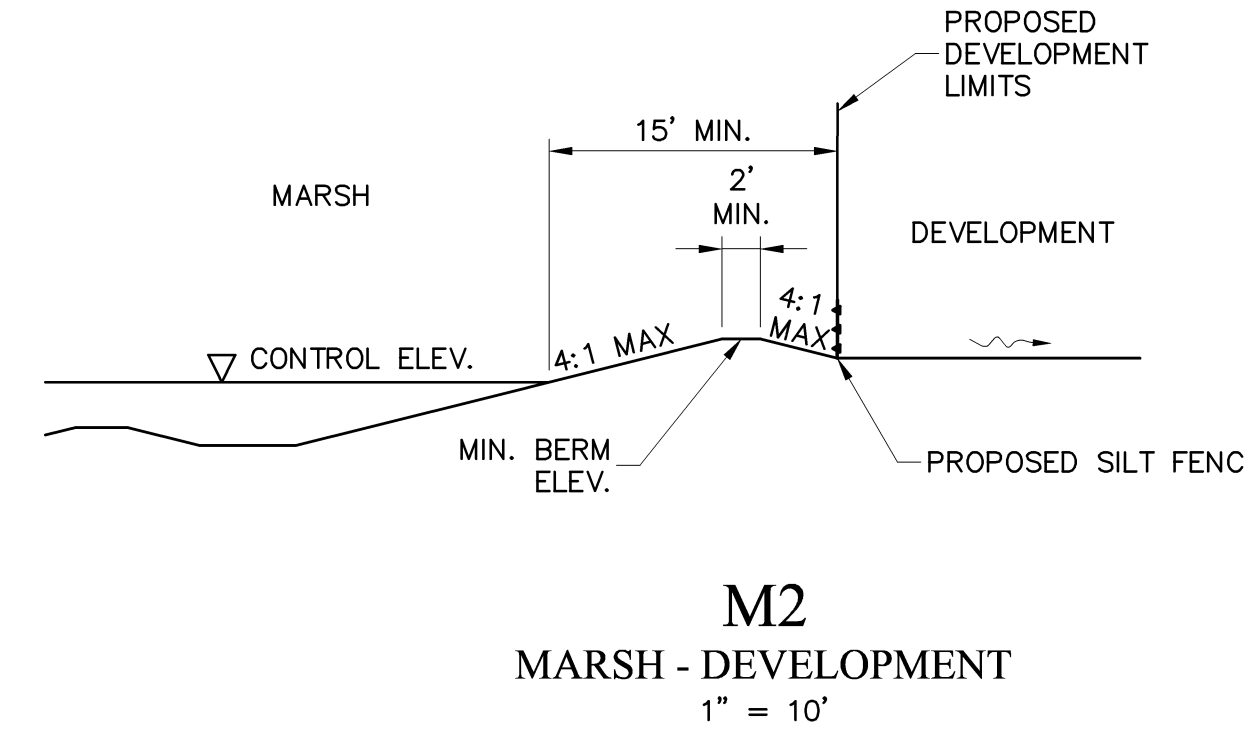
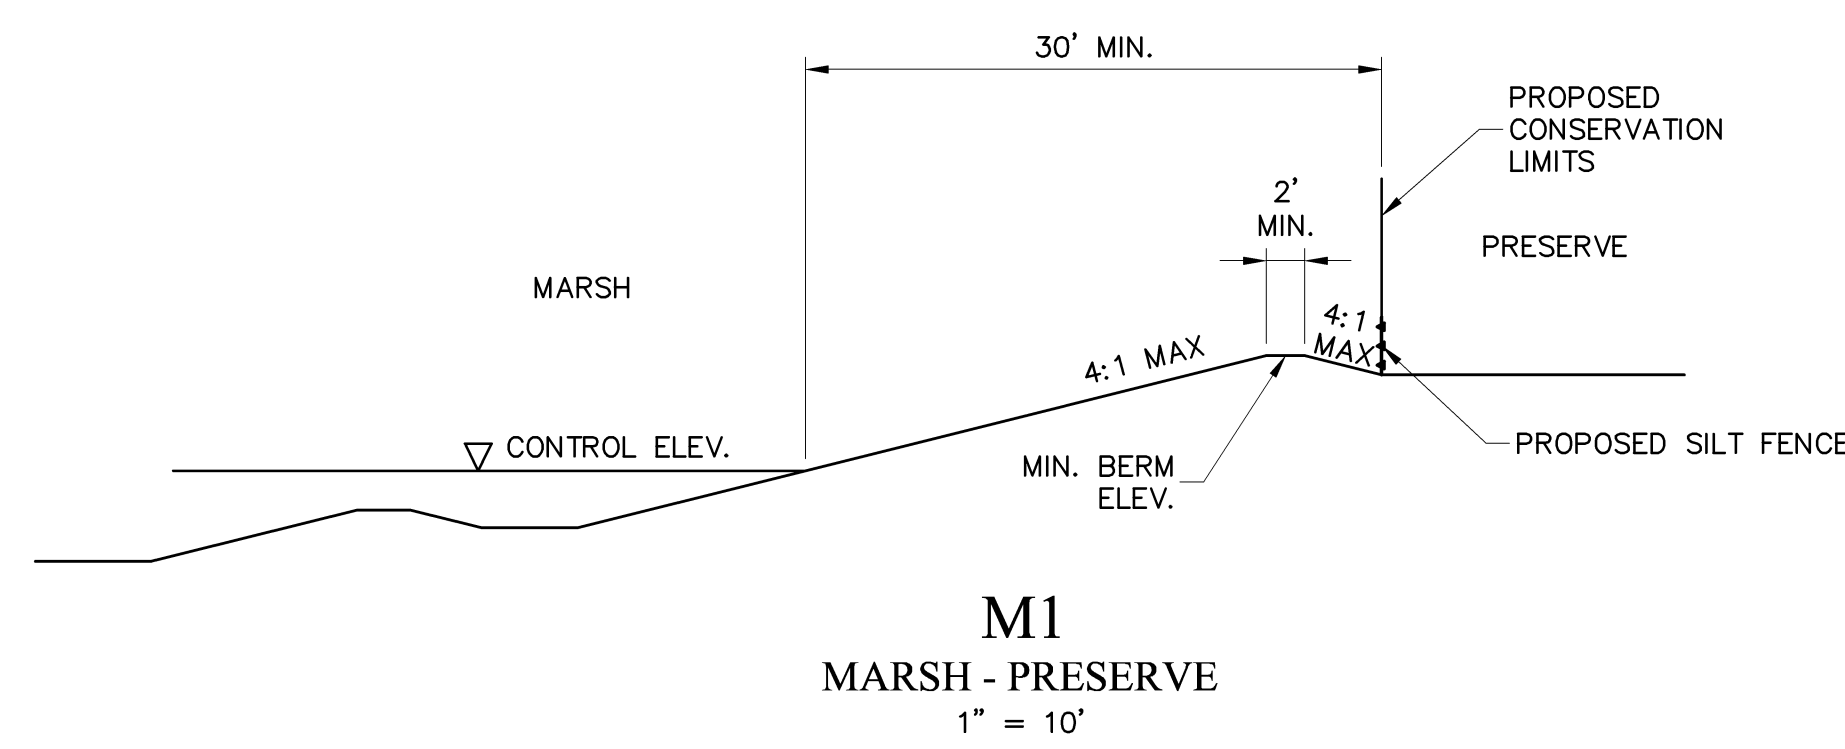
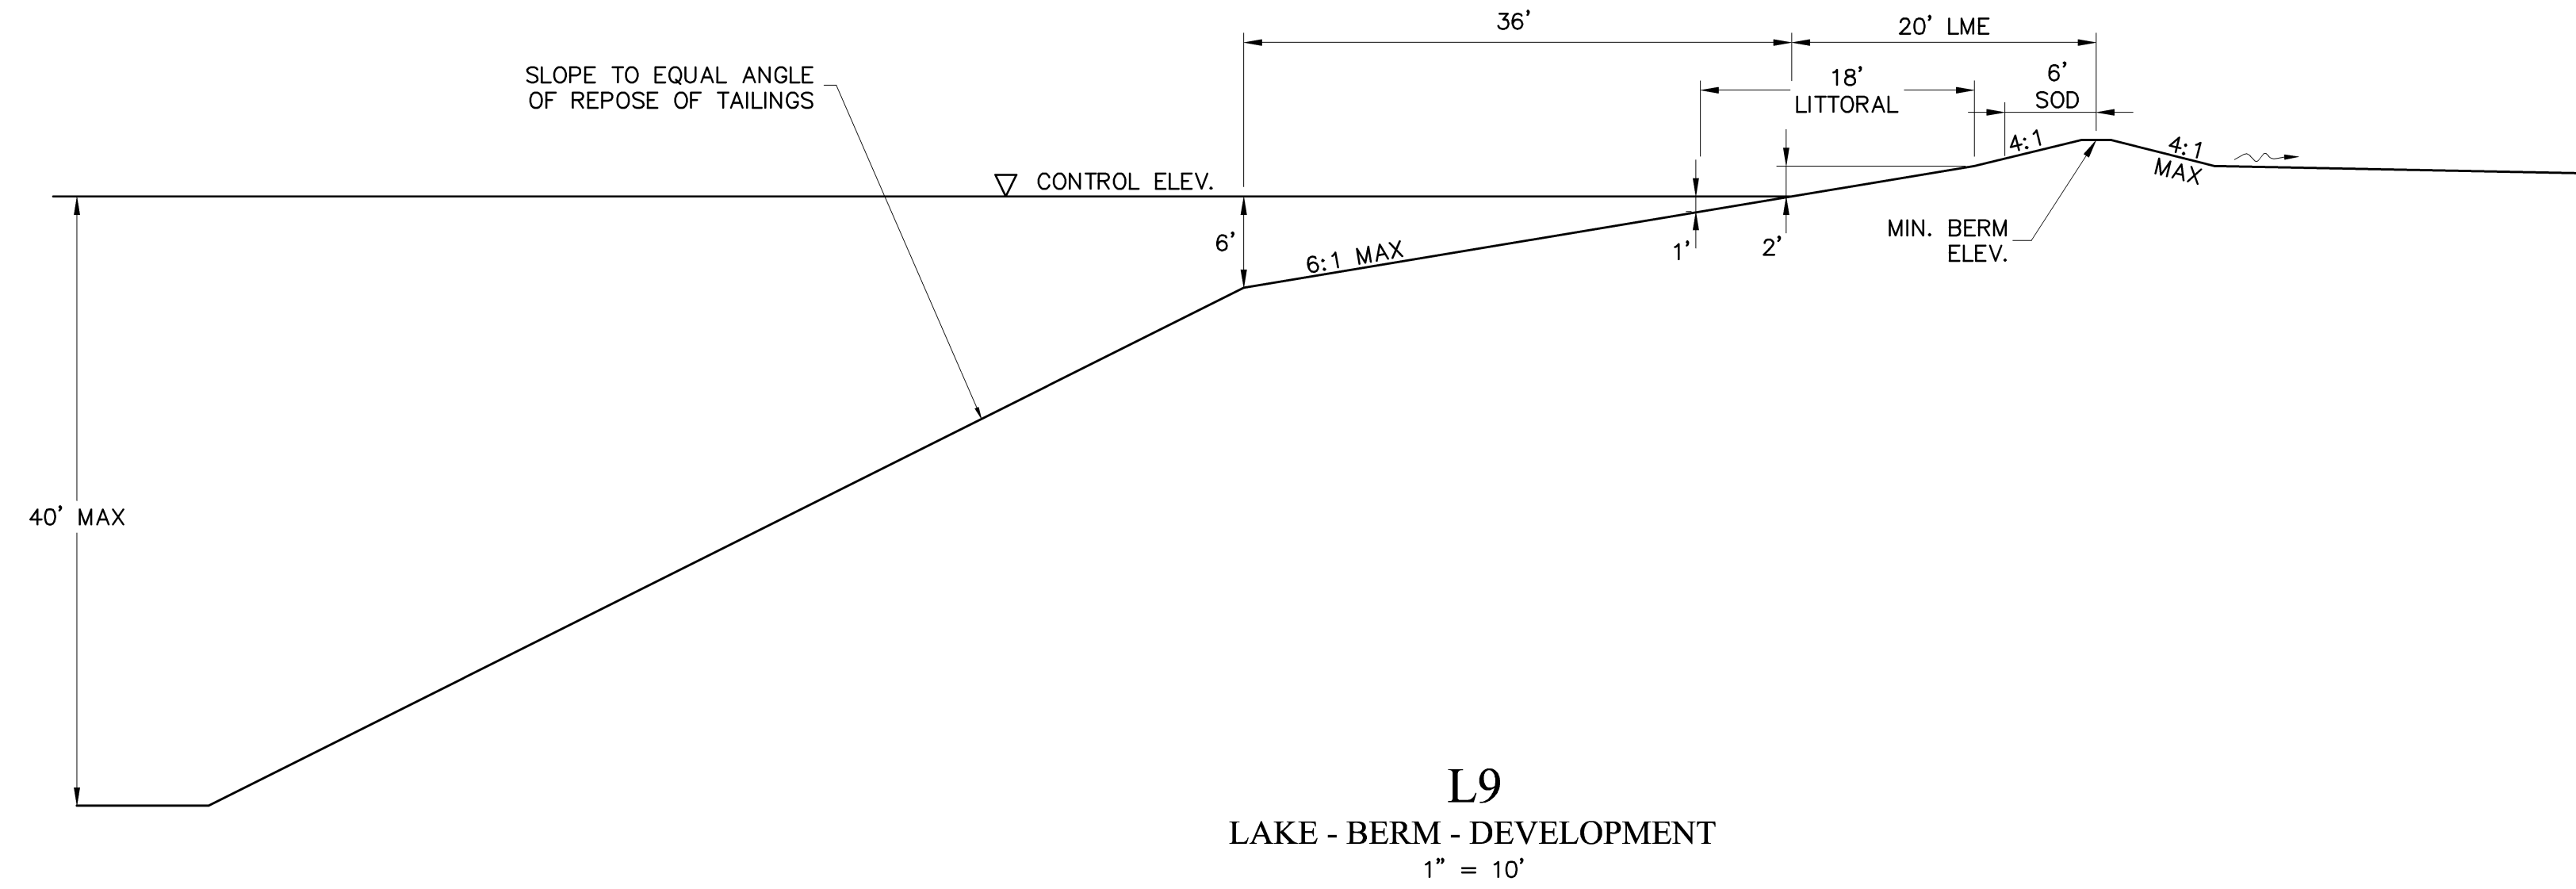


NO.	DESCRIPTION	DATE
1	ERP REVISIONS	01/20/08
2	ERP REVISIONS PER RAI #2	08/20/08

DATE: MARCH, 2007  
PROJECT NO. 20055693-206  
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SCALE: As Shown

TYPICAL SECTIONS

SHEET NUMBER

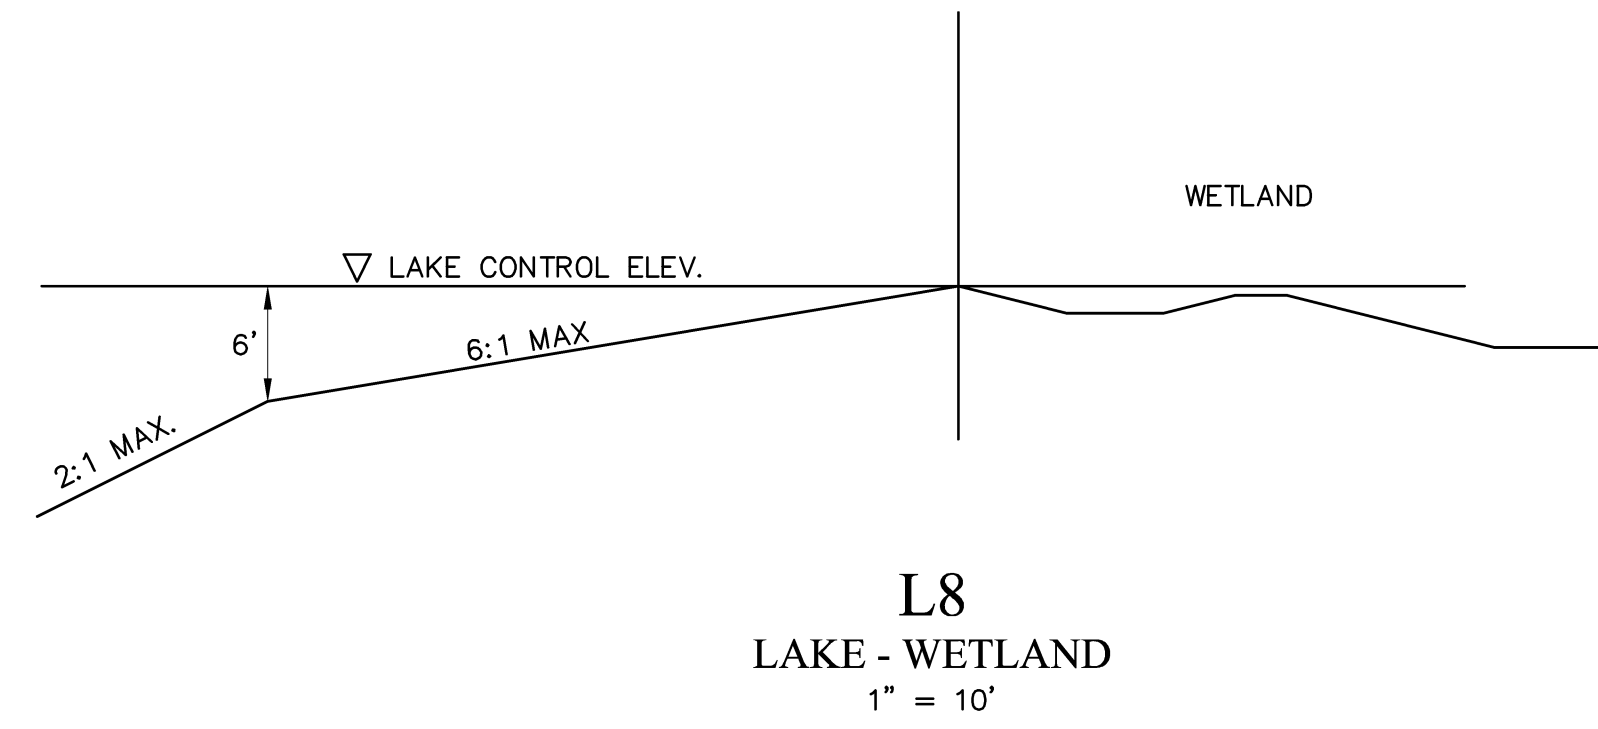

NO.	DESCRIPTION	DATE
1	ERP REVISIONS	01/20/08
2	ERP REVISIONS PER RAI #2	08/20/08

DATE: MARCH, 2007  
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SCALE: As Shown





TYPICAL  
SECTIONS







SHEET NUMBER

NO.	DESCRIPTION	DATE
1	ERP REVISIONS	01/20/08
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DATE: MARCH, 2007  
 PROJECT NO. 20055693-206  
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TYPICAL SECTIONS



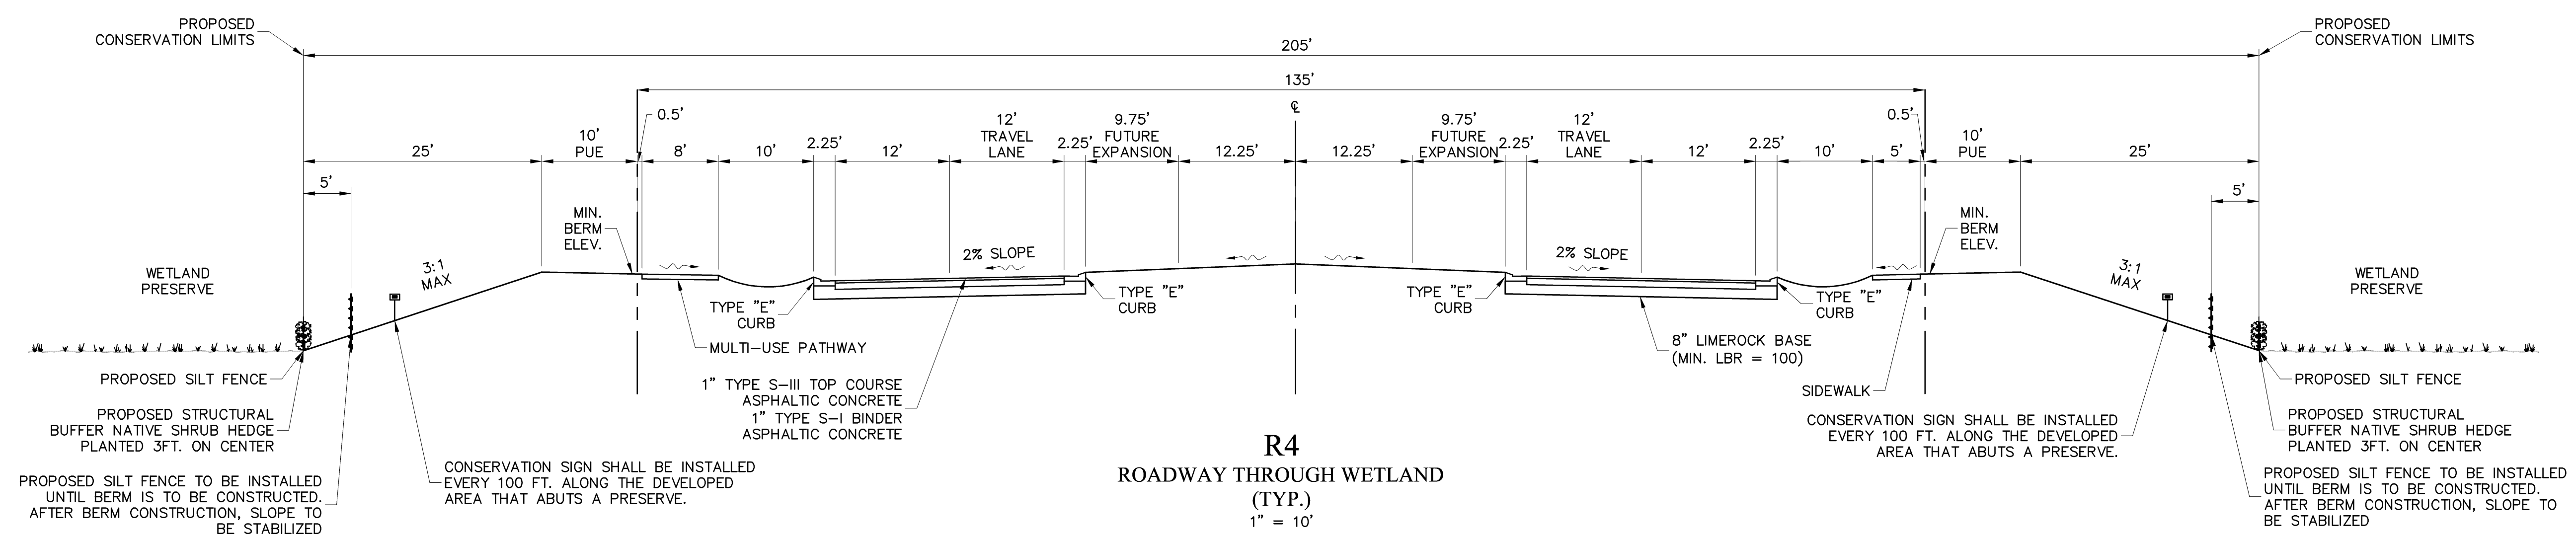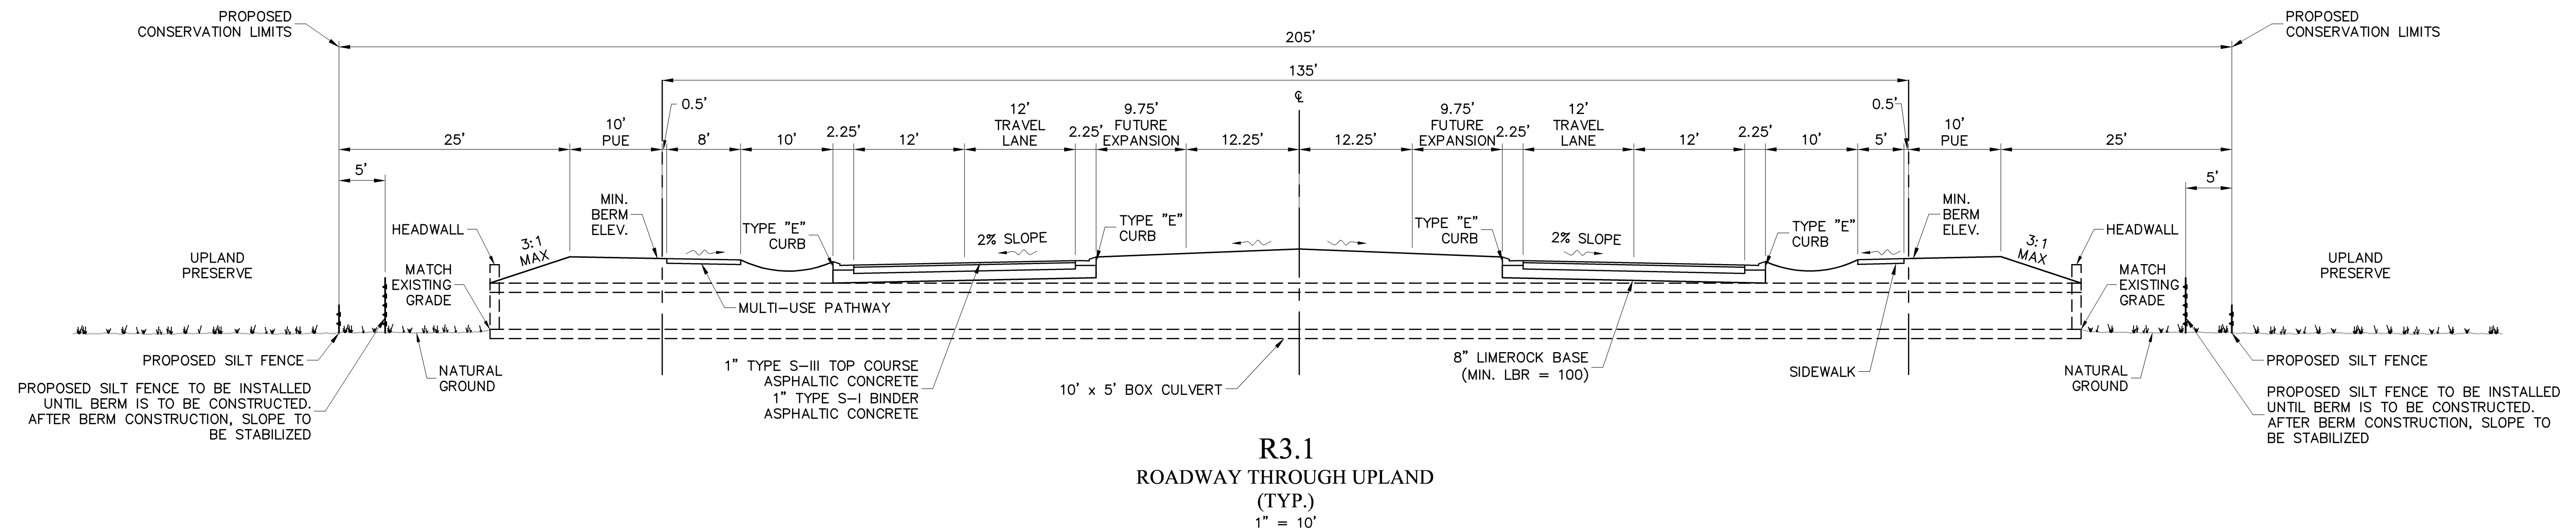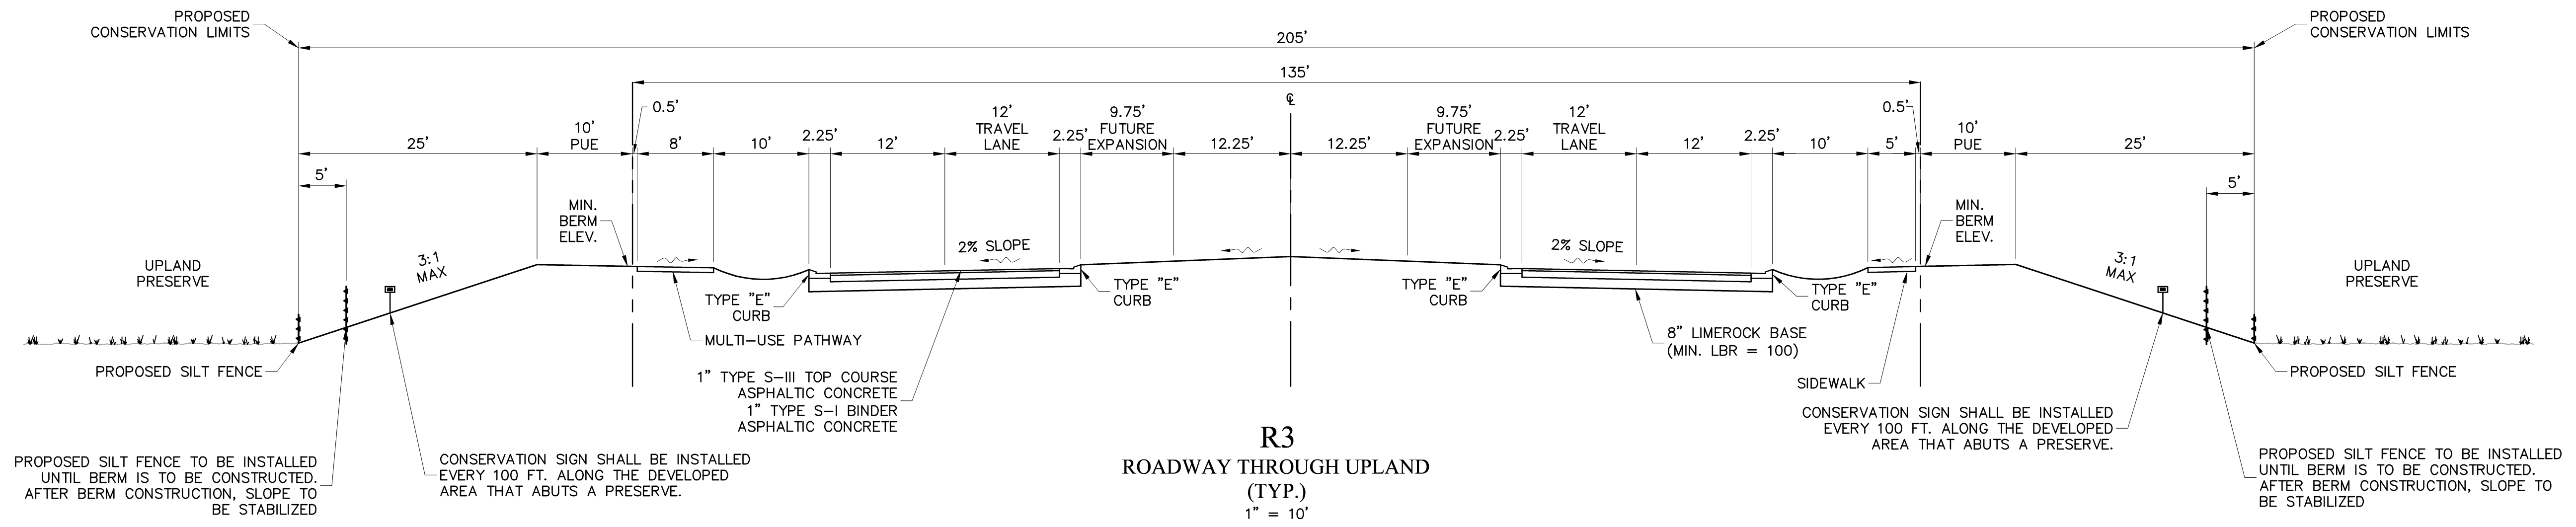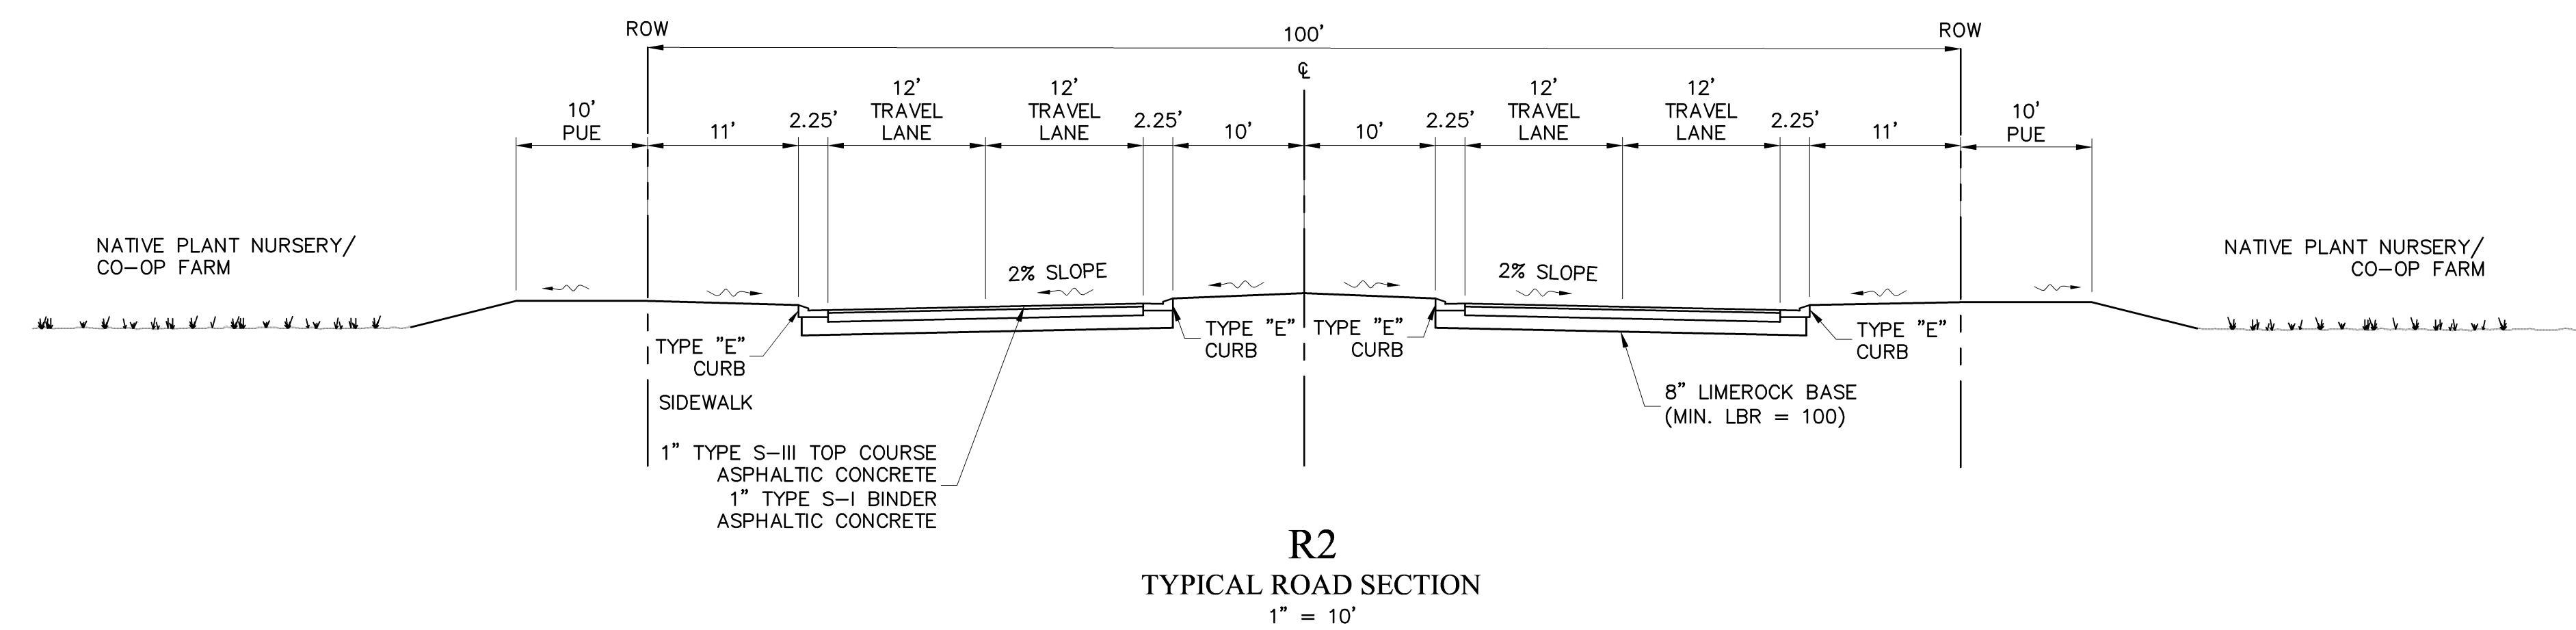


**REVISIONS**

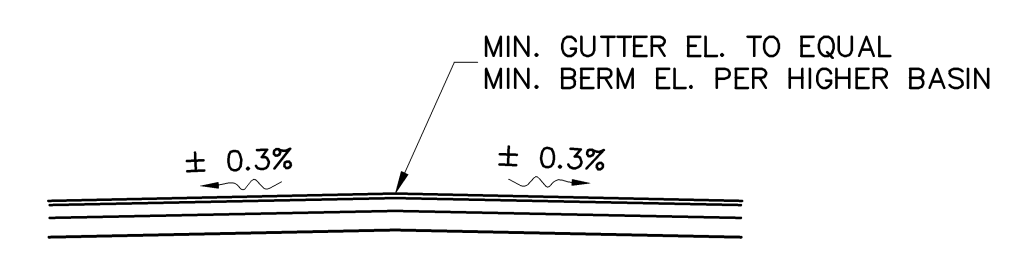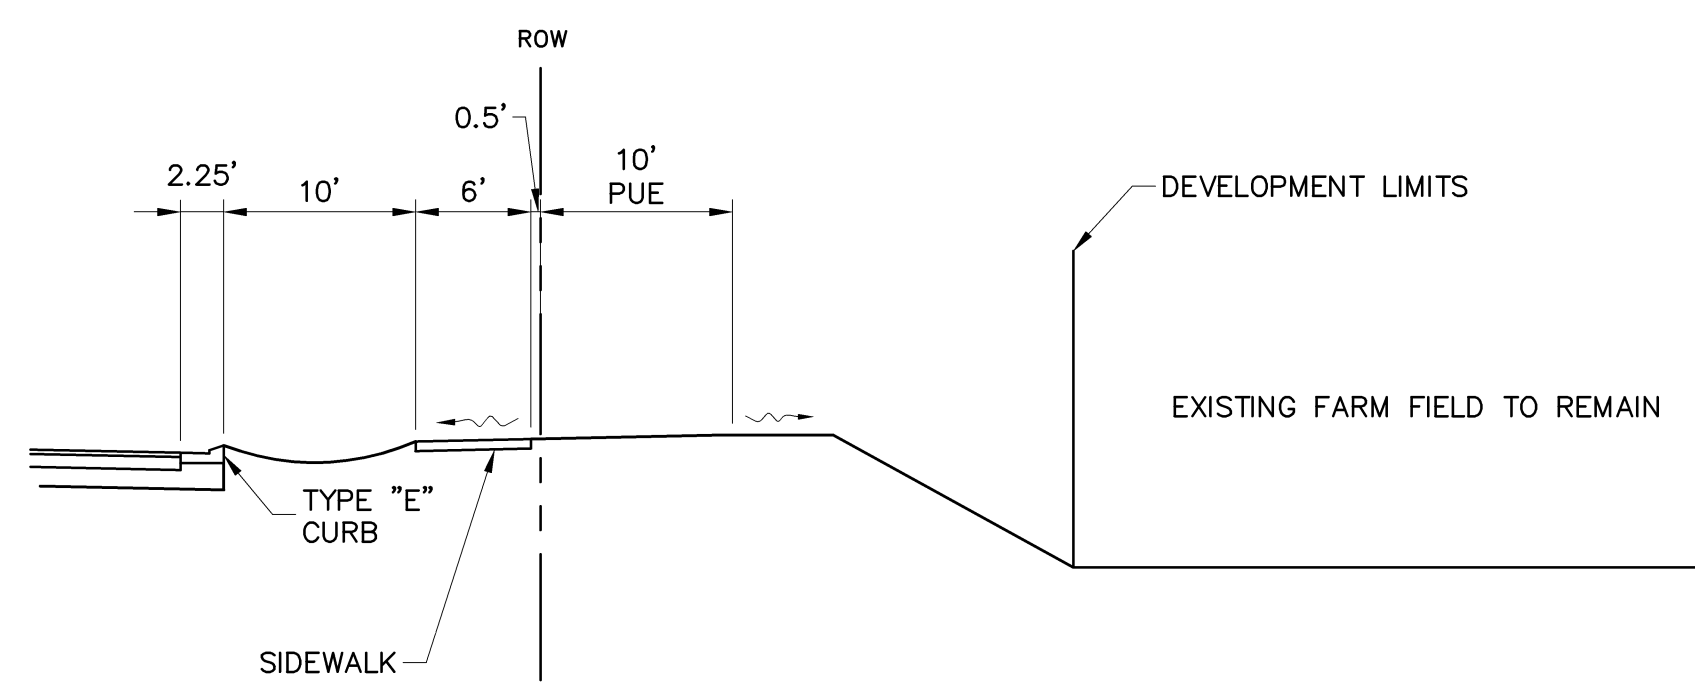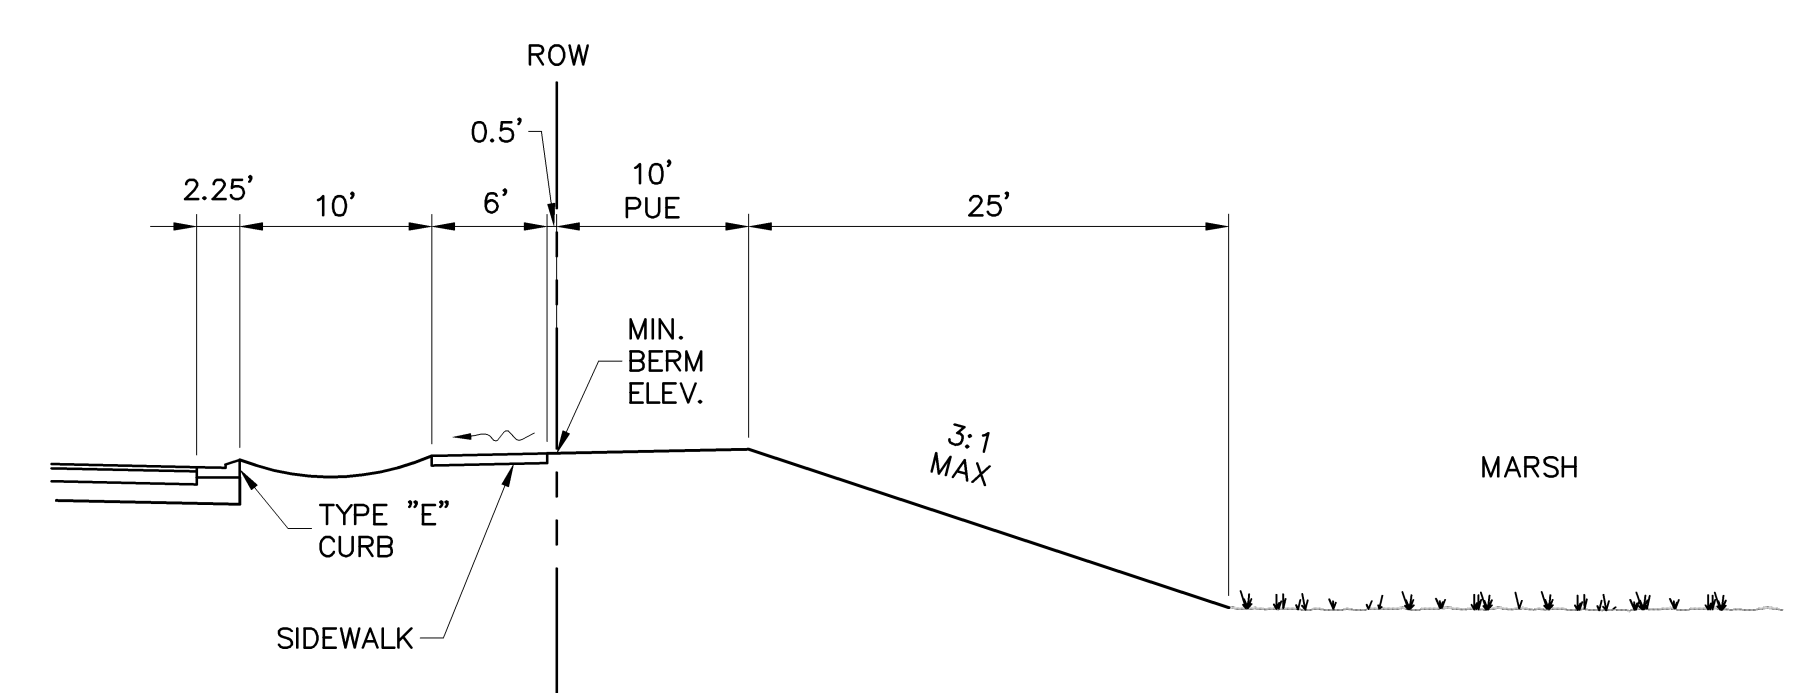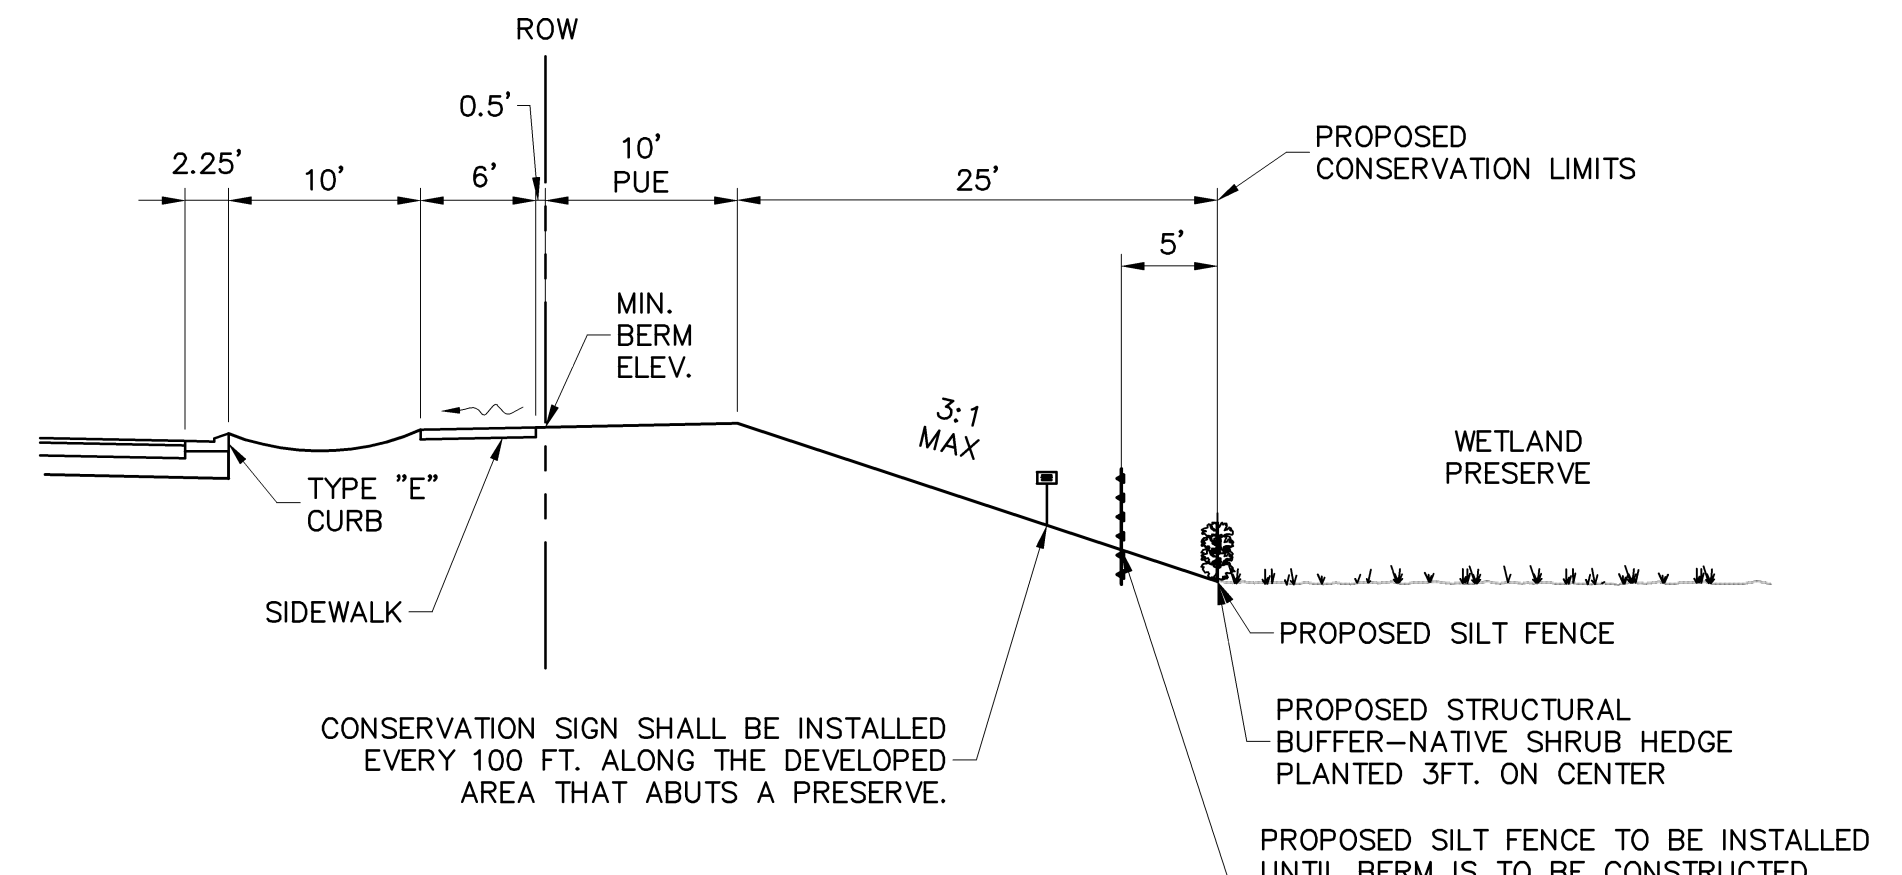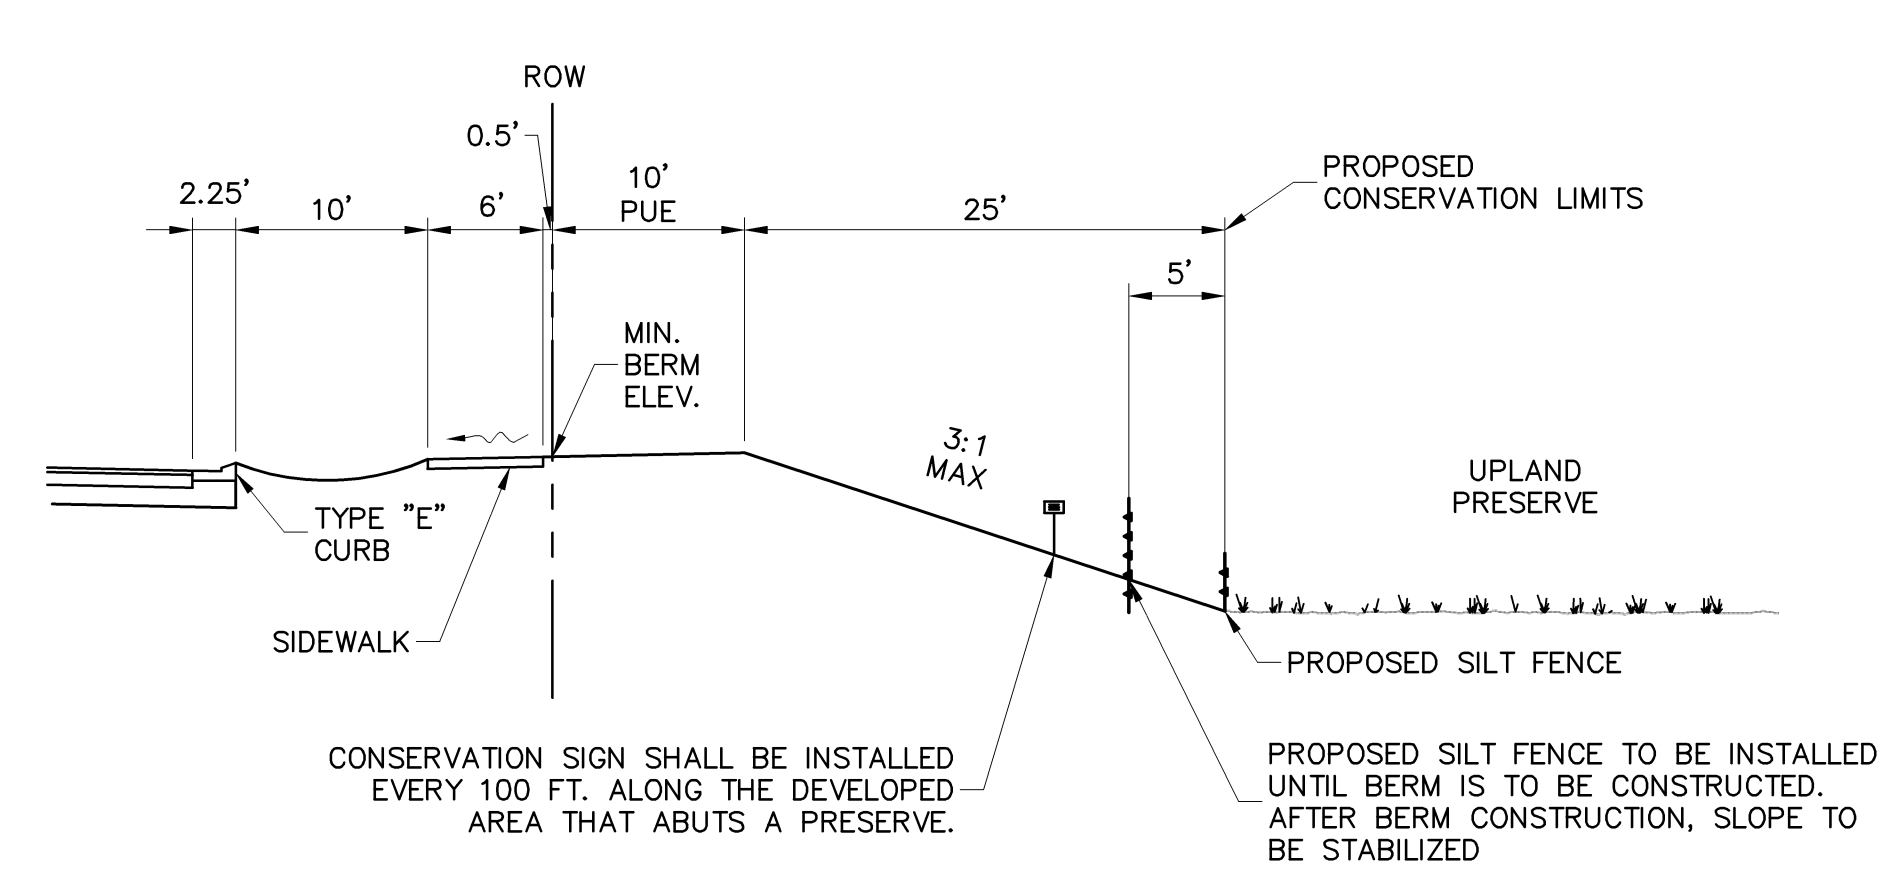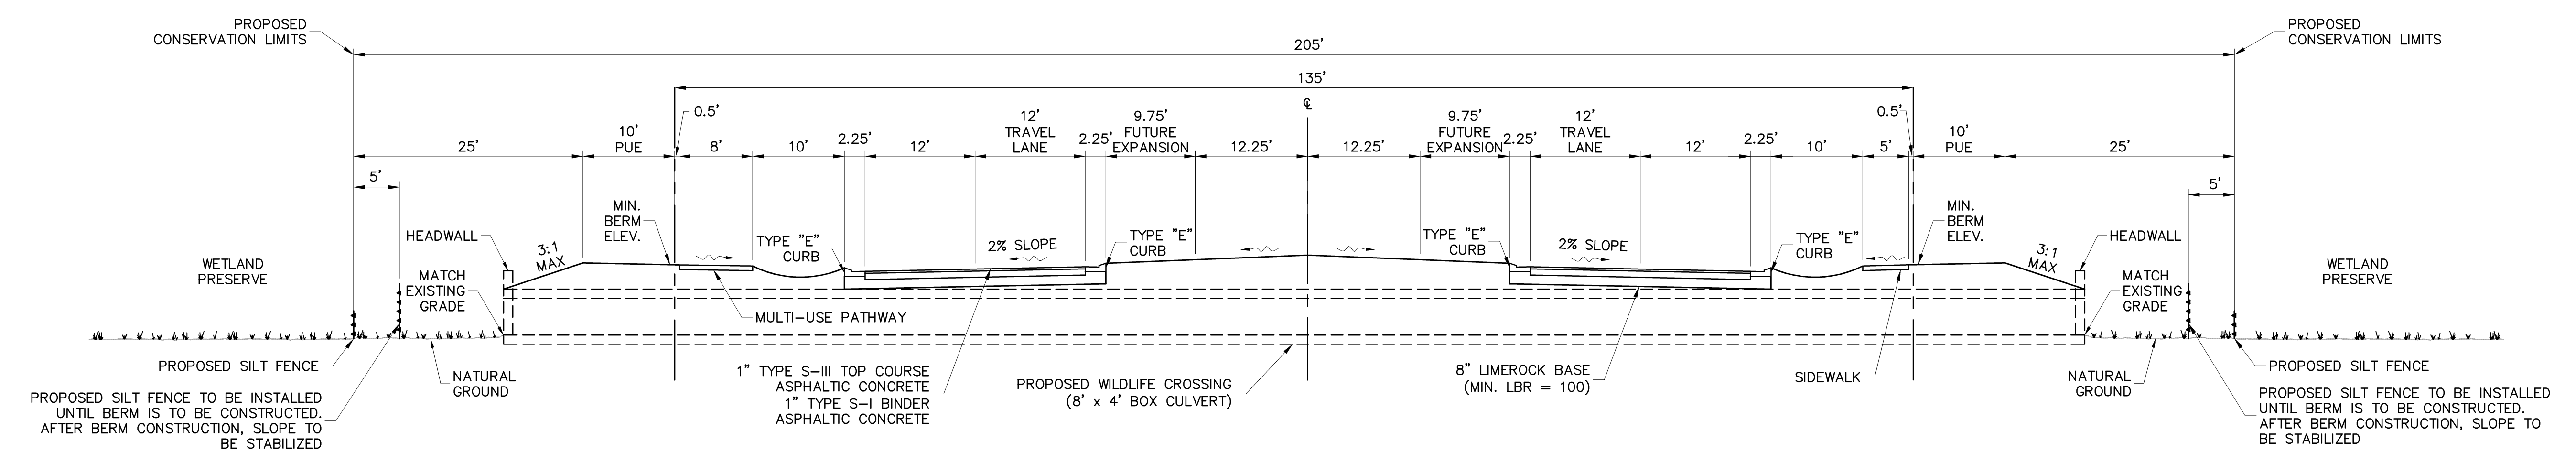NO.	DESCRIPTION	DATE
1	ERP REVISIONS	01/20/08
2	ERP REVISIONS PER RAI #2	08/20/08


DATE: MARCH, 2007  
 PROJECT NO. 20055693-206  
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TYPICAL SECTIONS

SHEET NUMBER

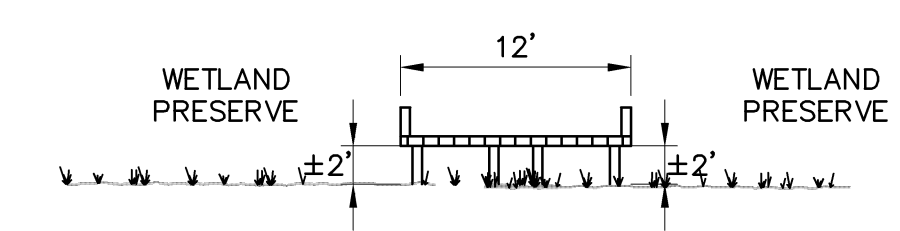


**T2 MULTI-USE BOARDWALK**  
 1" = 10'

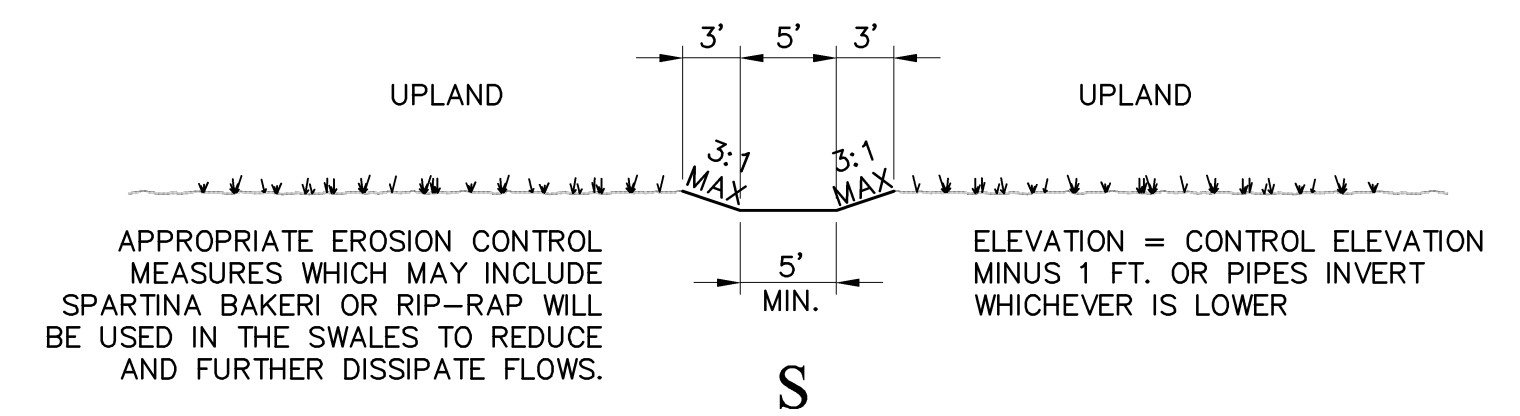


**S OUTFALL SWALE**  
 1" = 10'


APPROPRIATE EROSION CONTROL MEASURES WHICH MAY INCLUDE SPARTINA BAKERI OR RIP-RAP WILL BE USED IN THE SWALES TO REDUCE AND FURTHER DISSIPATE FLOWS.  
 ELEVATION = CONTROL ELEVATION MINUS 1 FT. OR PIPES INVERT WHICHEVER IS LOWER

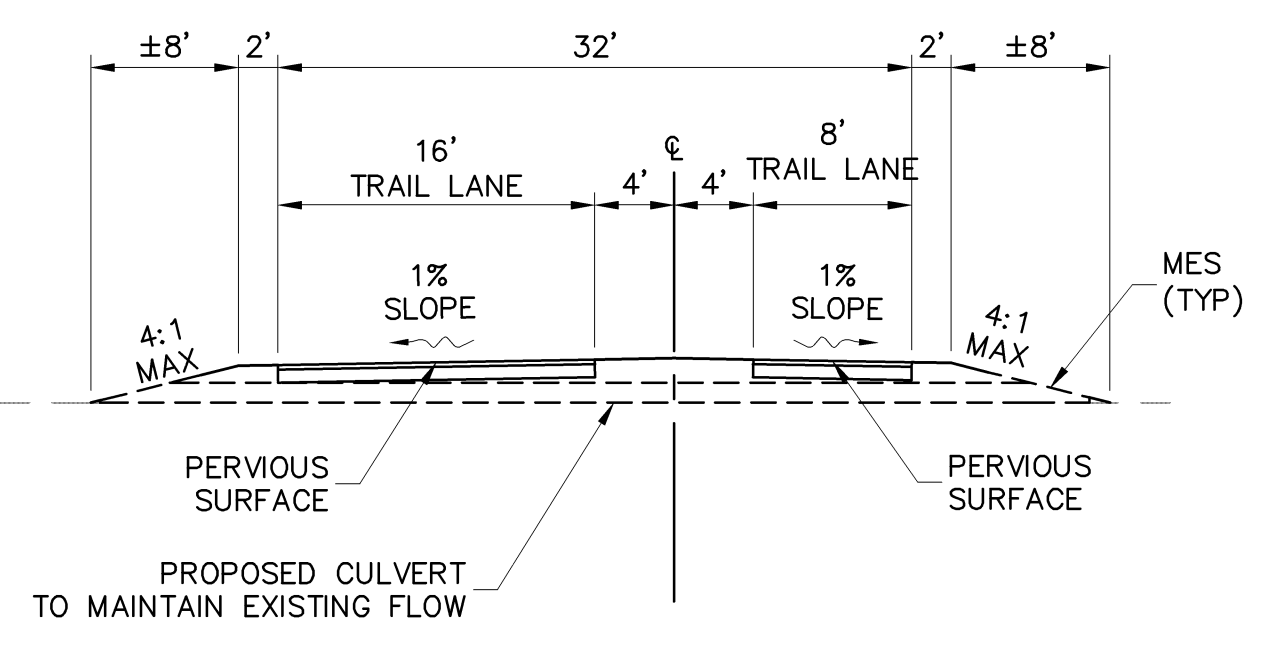


**TYPE - II A MULTI-USE TRAIL**  
 1" = 10'

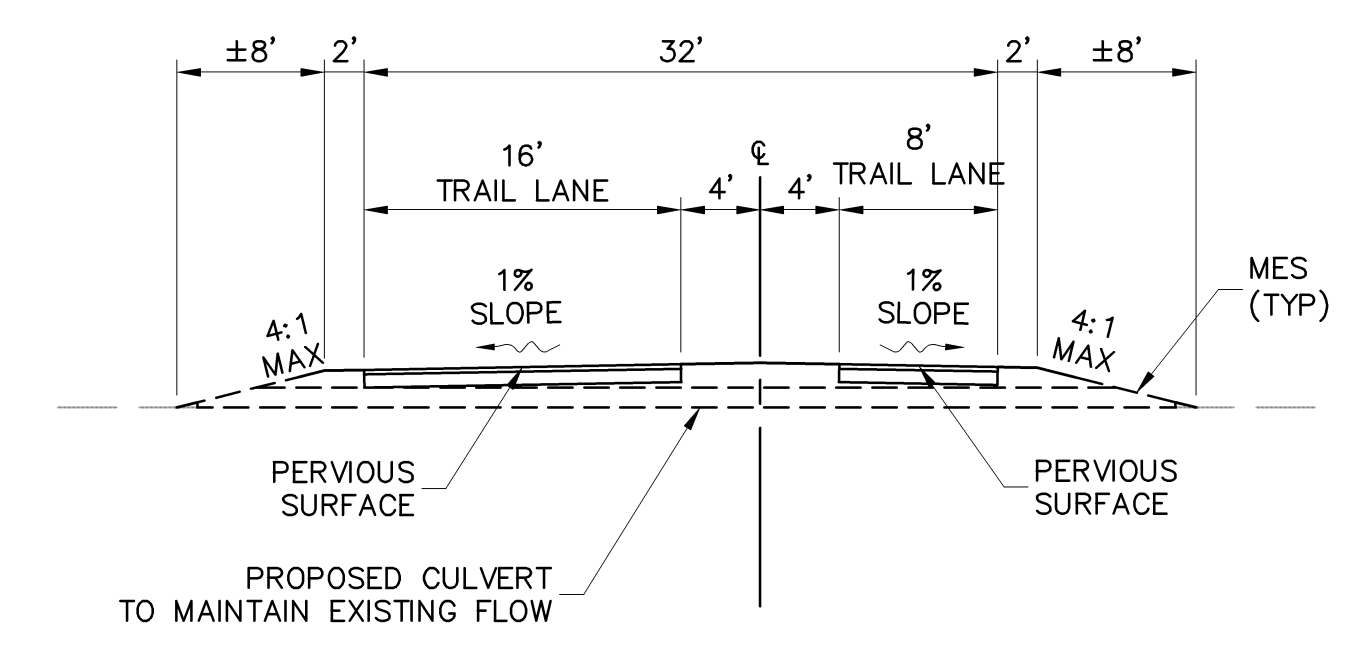


**TYPE - II B MULTI-USE TRAIL**  
 1" = 10'

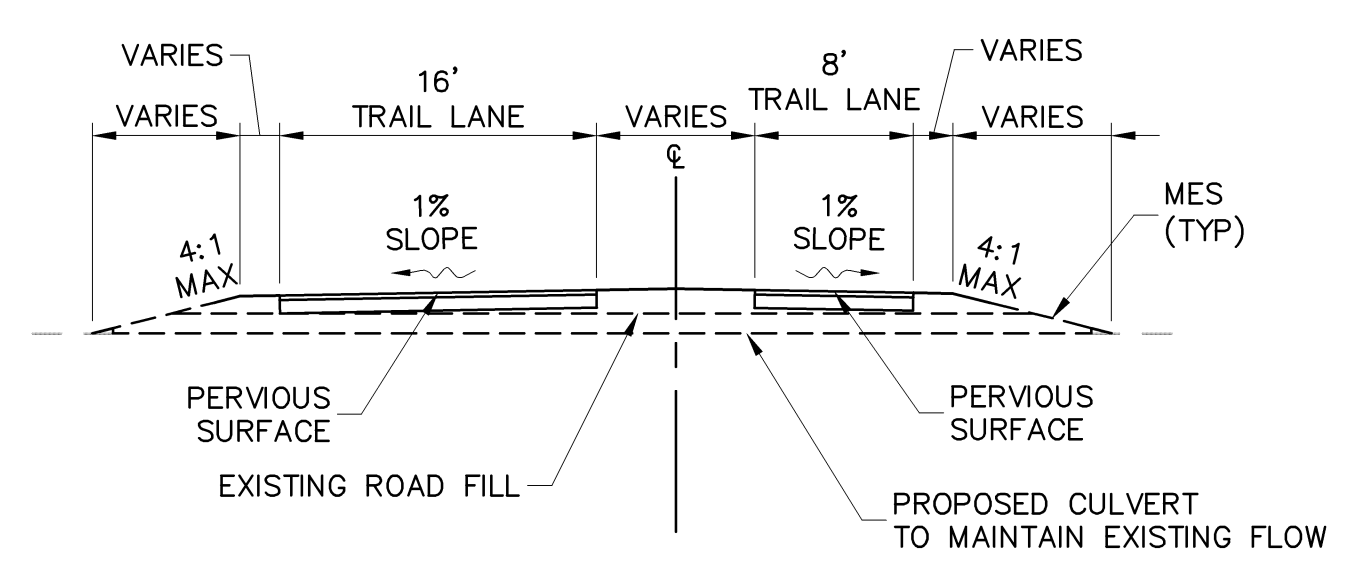


**TYPE - III MULTI-USE TRAIL**  
 1" = 10'

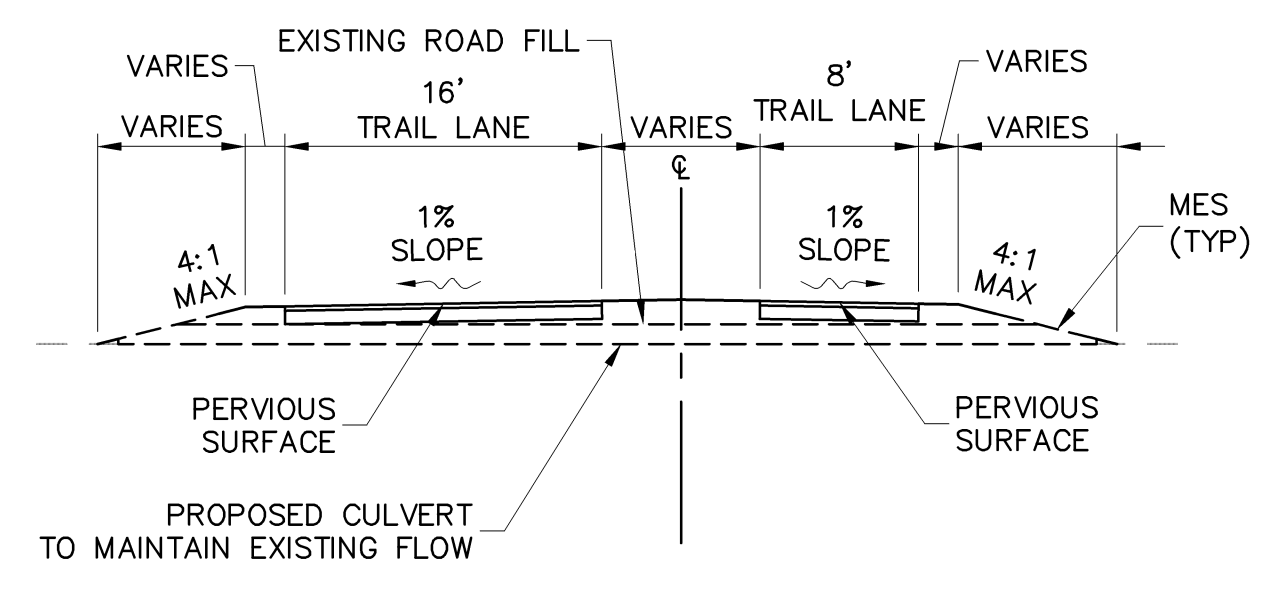


**TYPE - IV MULTI-USE TRAIL**  
 1" = 10'

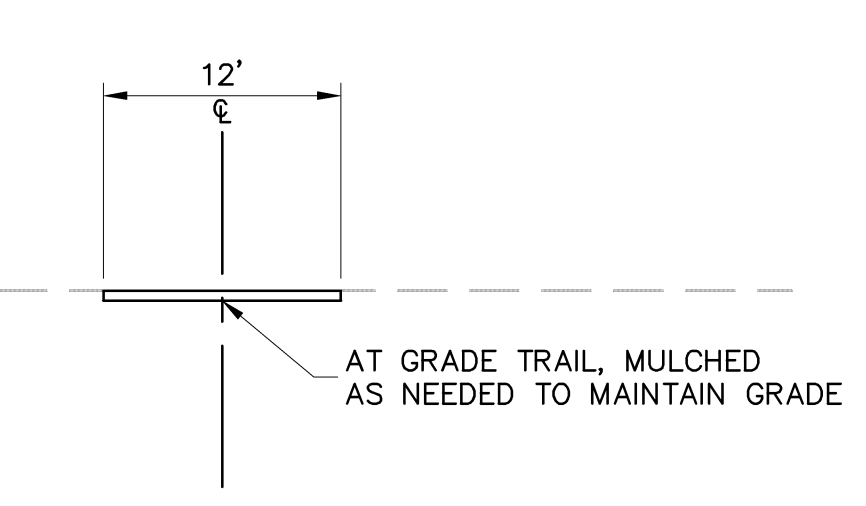


**TYPE - V MULTI-USE TRAIL**  
 1" = 10'

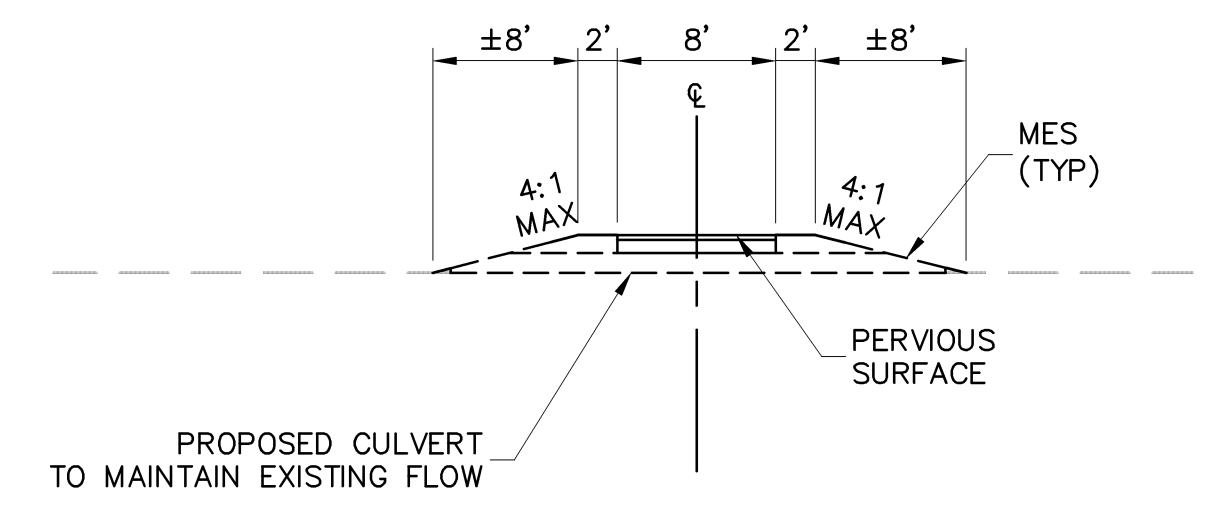


**TYPE - VI A MULTI-USE TRAIL**  
 1" = 10'

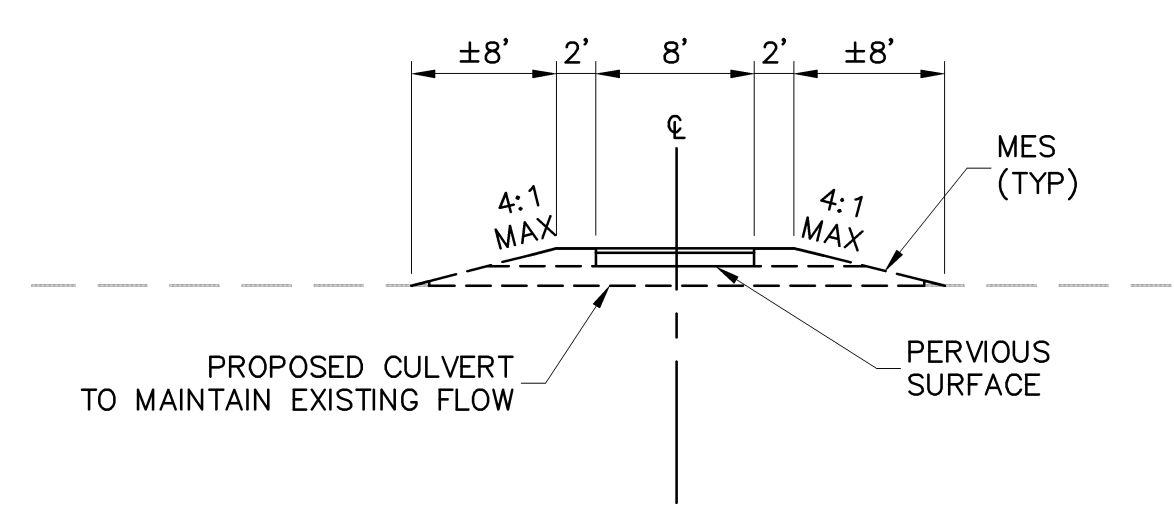


**TYPE - VI B MULTI-USE TRAIL**  
 1" = 10'

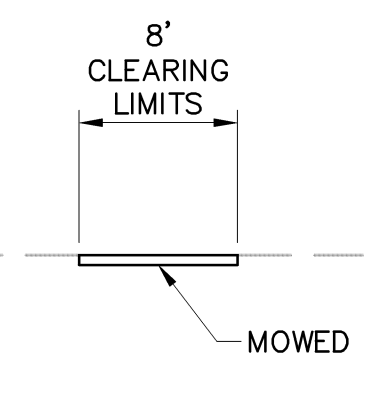


**TYPE - VII MULTI-USE TRAIL**  
 1" = 10'

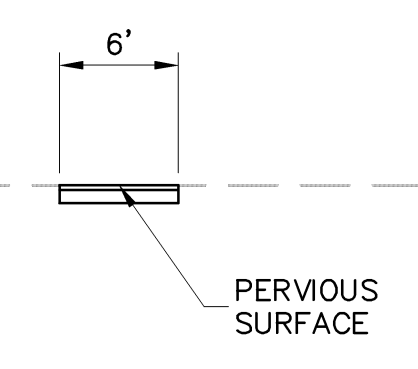


**TYPE - VIII MULTI-USE TRAIL**  
 1" = 10'

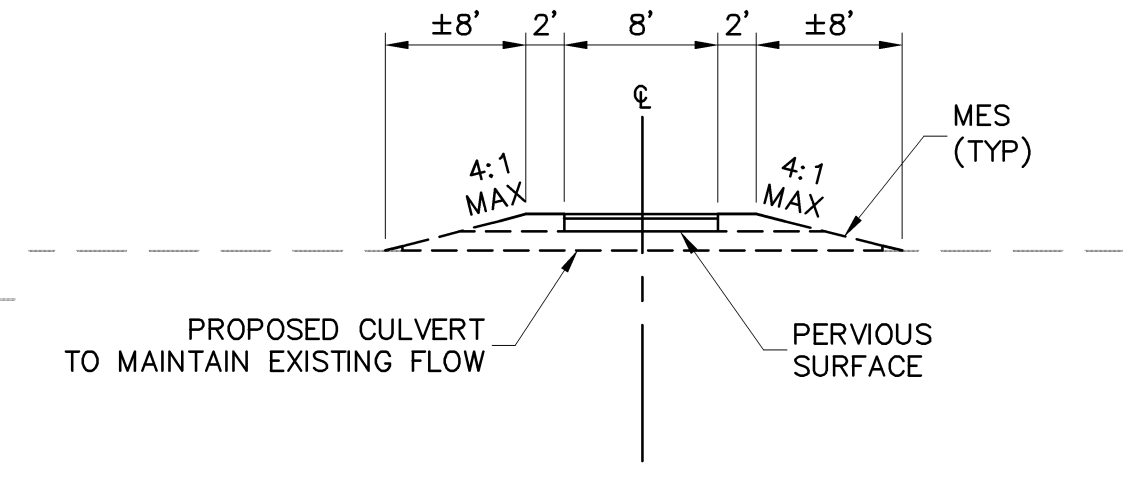

**TYPE - IX MULTI-USE TRAIL**  
 1" = 10'

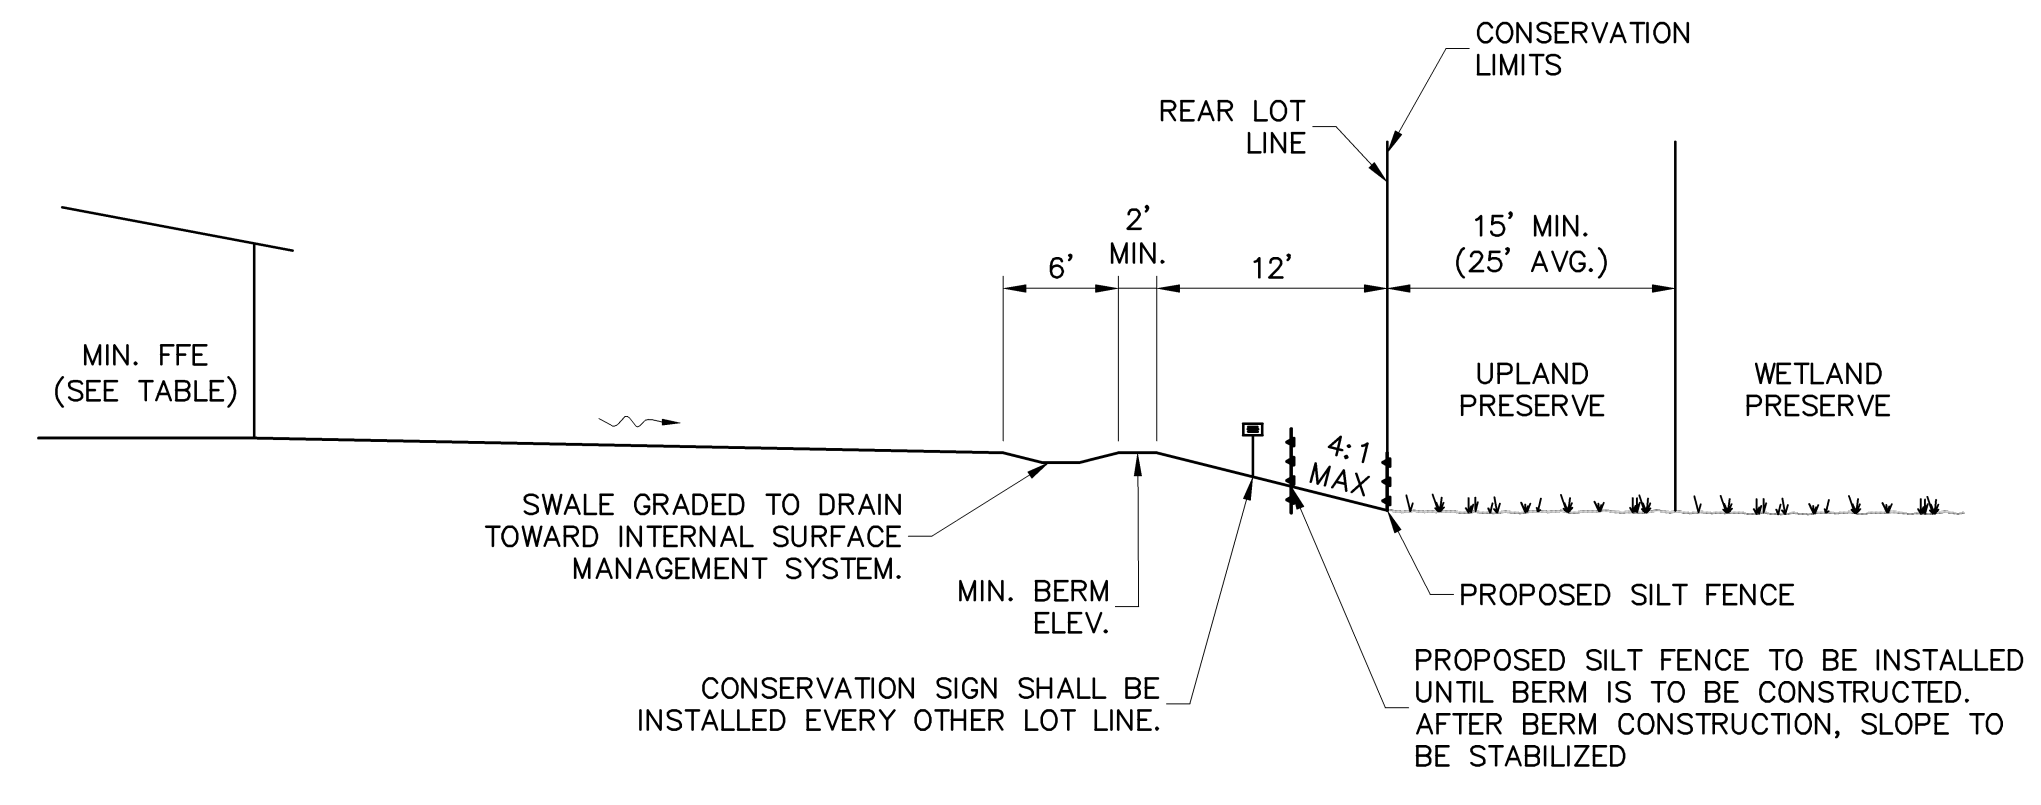

**TYPICAL RESIDENCE - EXTERNAL UPLAND PRESERVE**  
 1" = 10'

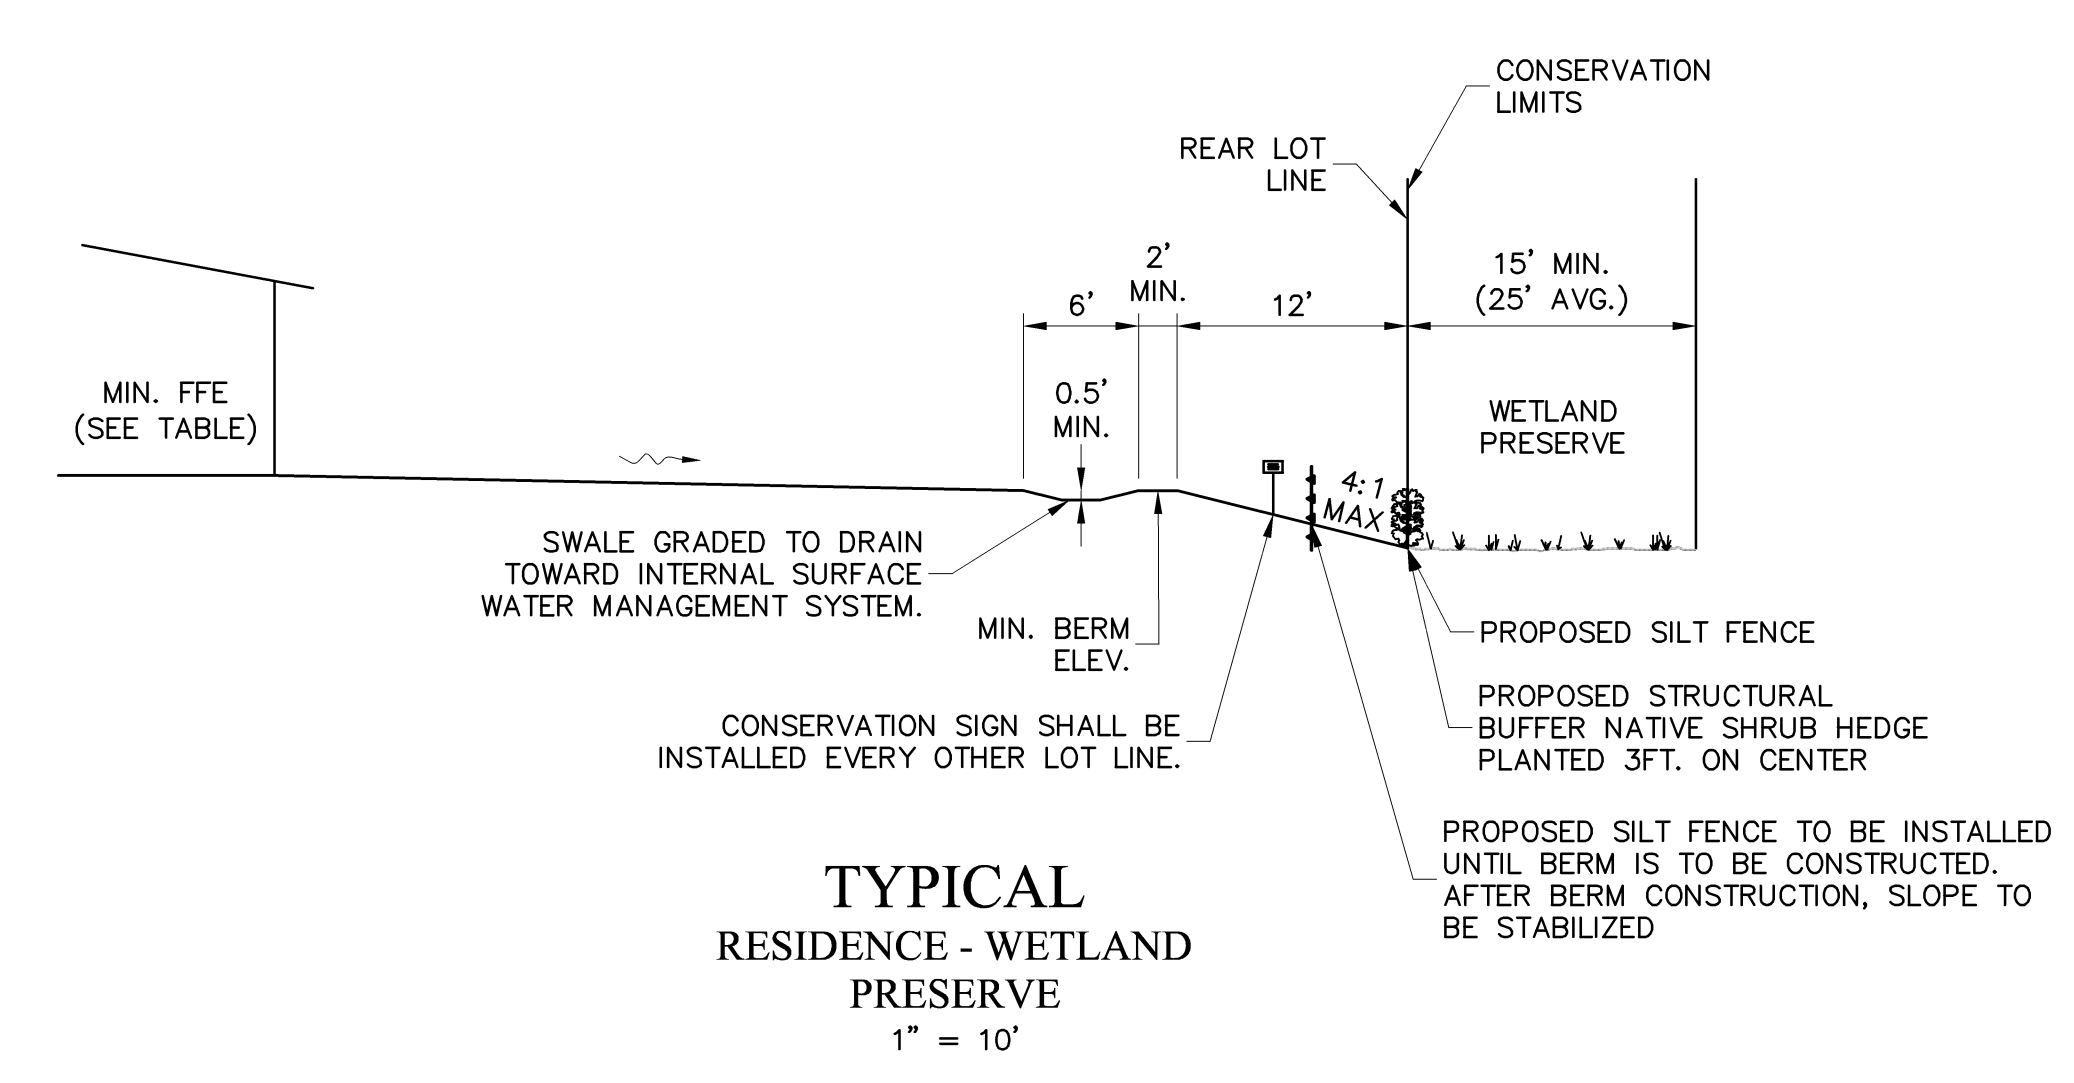

**TYPICAL RESIDENCE - WETLAND PRESERVE**  
 1" = 10'

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TYPICAL SECTIONS


SHEET NUMBER

NO.	DESCRIPTION	DATE
1	ERP REVISIONS	01/20/08
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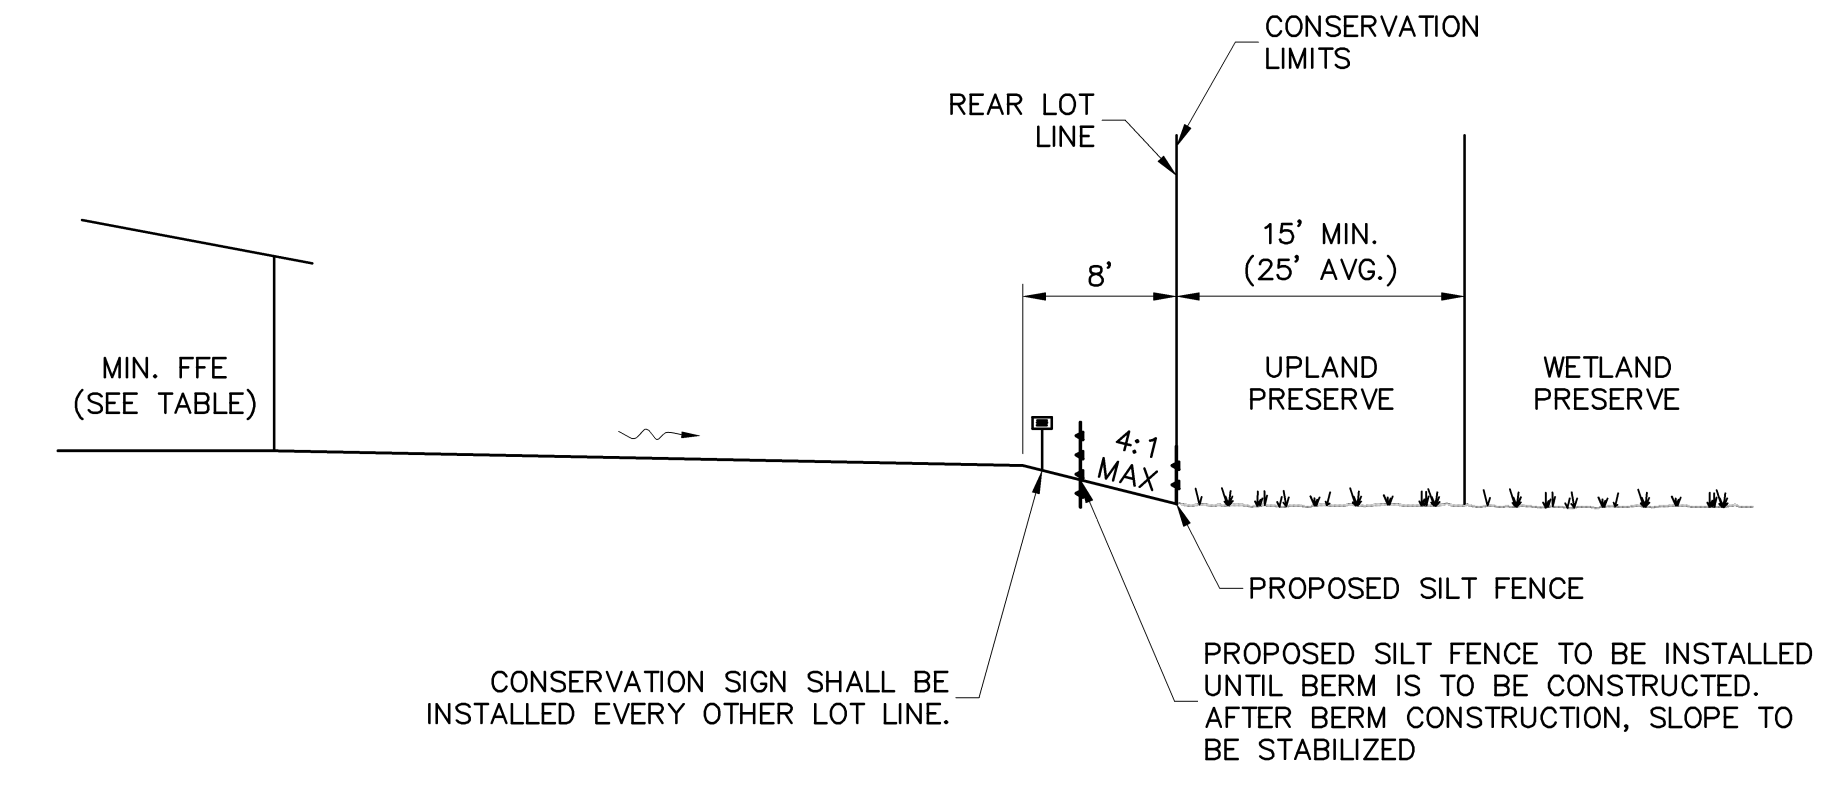
DATE: MARCH, 2007  
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TYPICAL SECTIONS


SHEET NUMBER



**TYPICAL RESIDENCE - LAKE**  
 1" = 10'

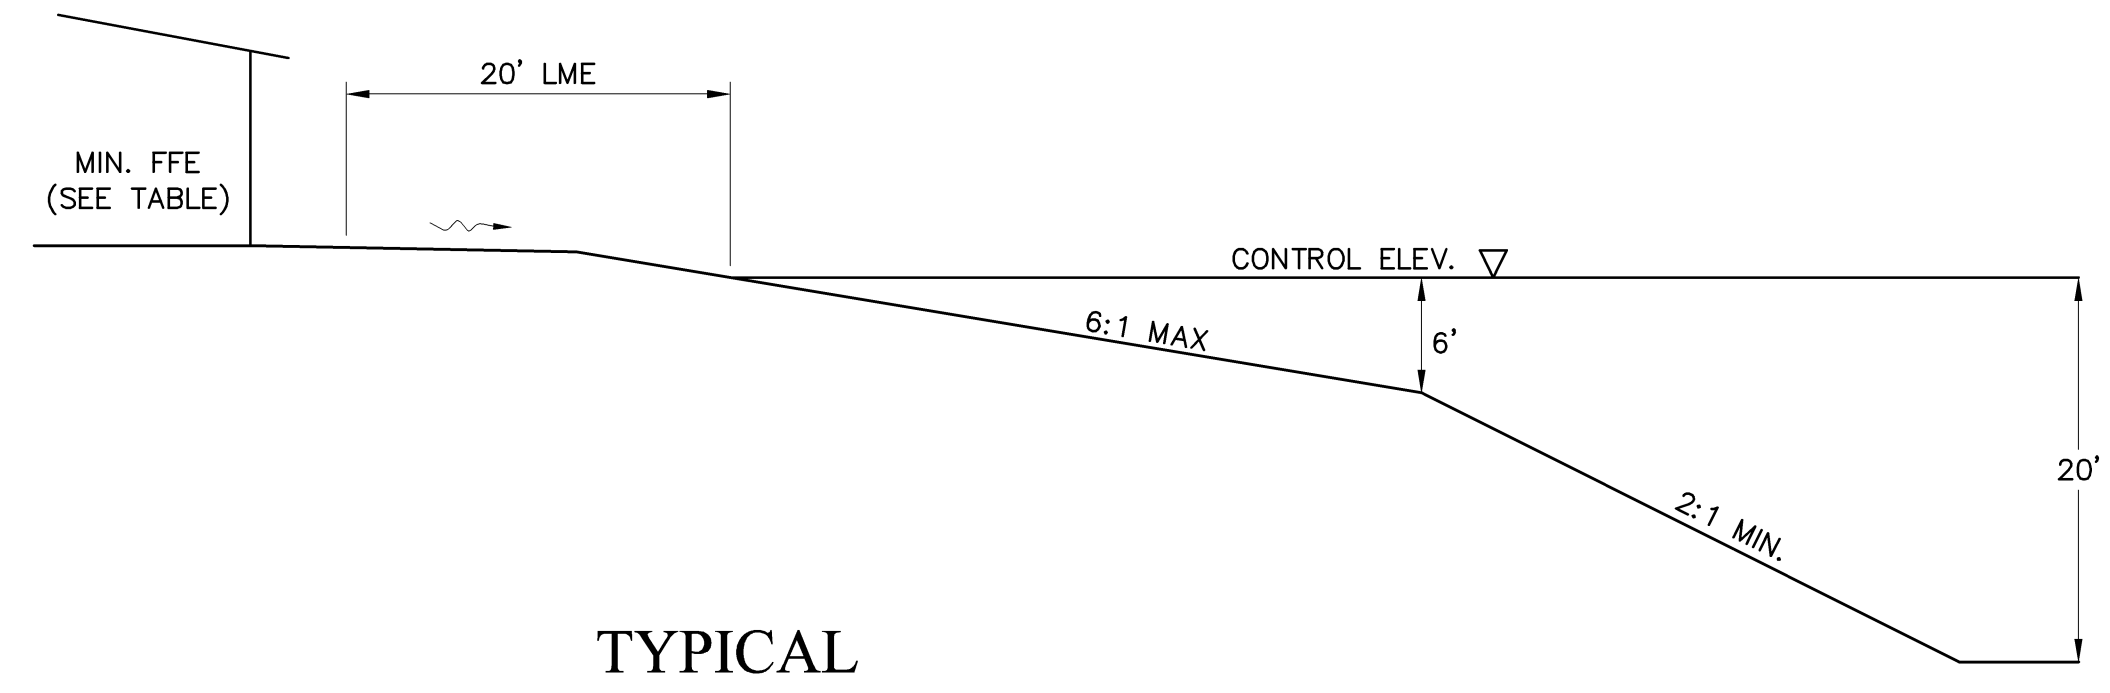


**TYPICAL RESIDENCE - INTERNAL UPLAND PRESERVE**  
 1" = 10'

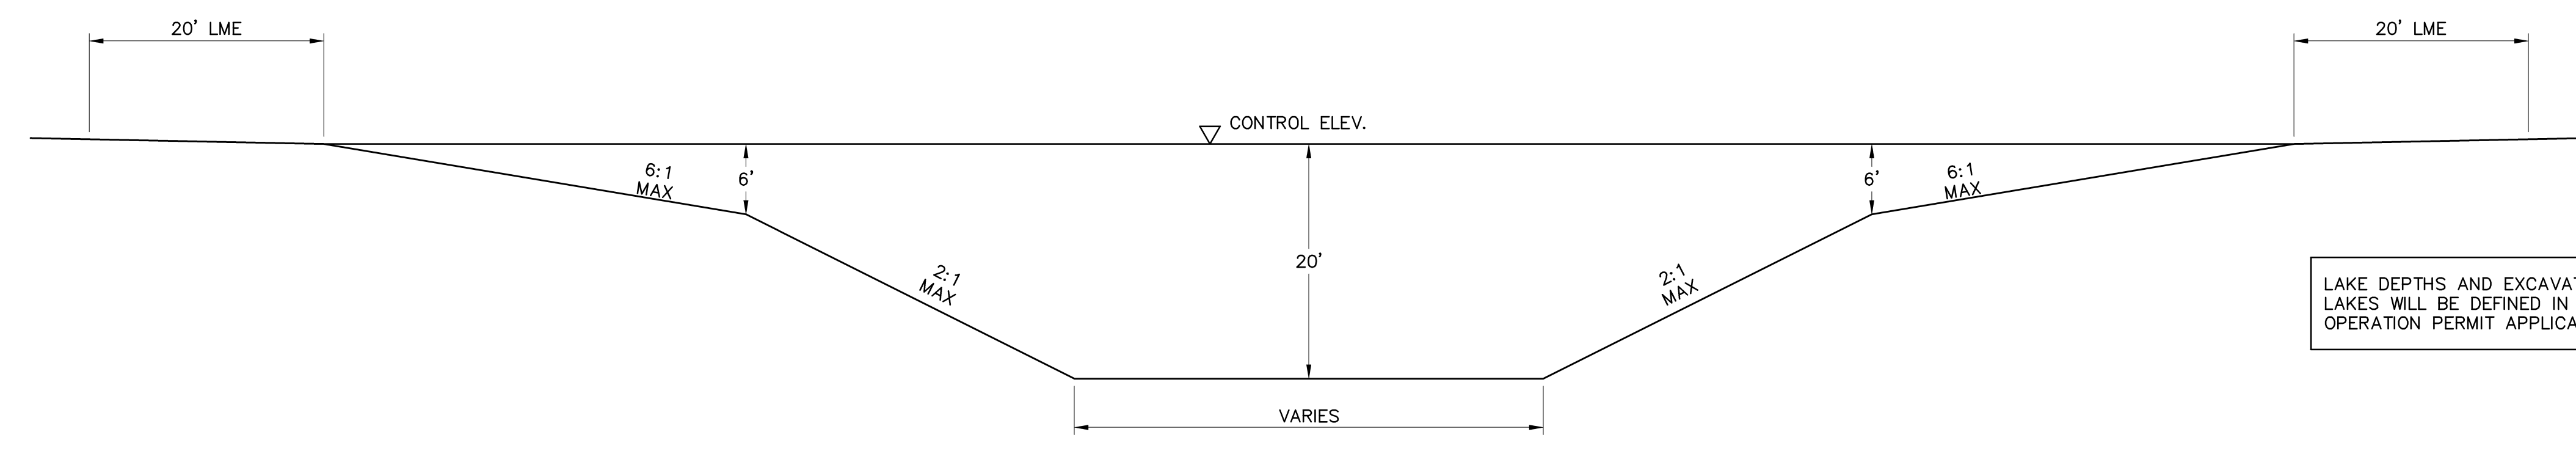


**TYPICAL LAKE**  
 1" = 10'


LAKE DEPTHS AND EXCAVATION METHODS FOR ALL NON-MINING LAKES WILL BE DEFINED IN FUTURE CONSTRUCTION AND OPERATION PERMIT APPLICATIONS.

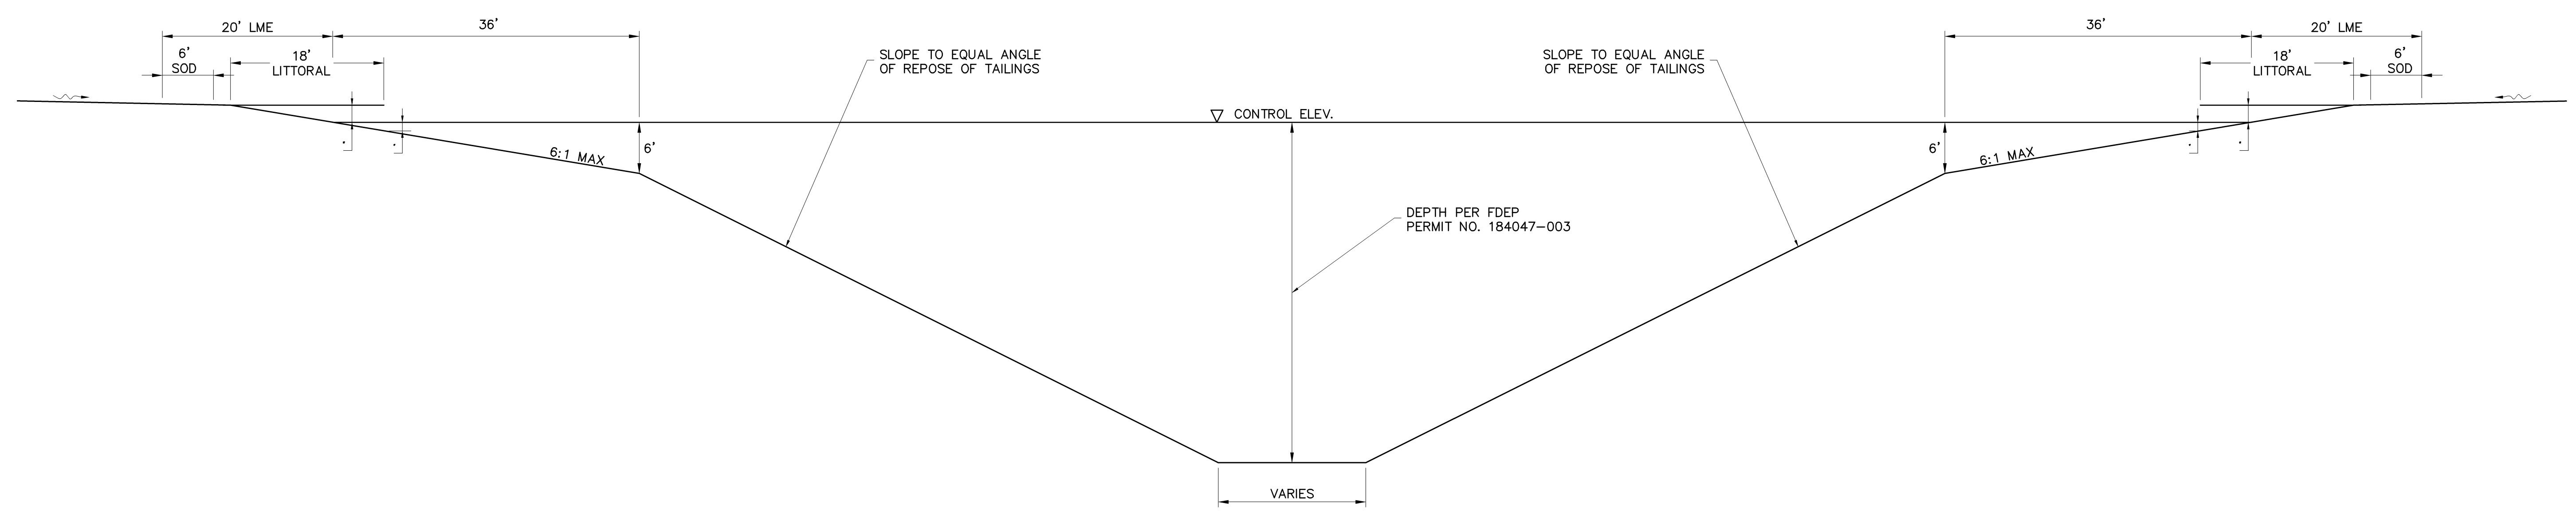

**TYPICAL MINING LAKE**  
 1" = 10'

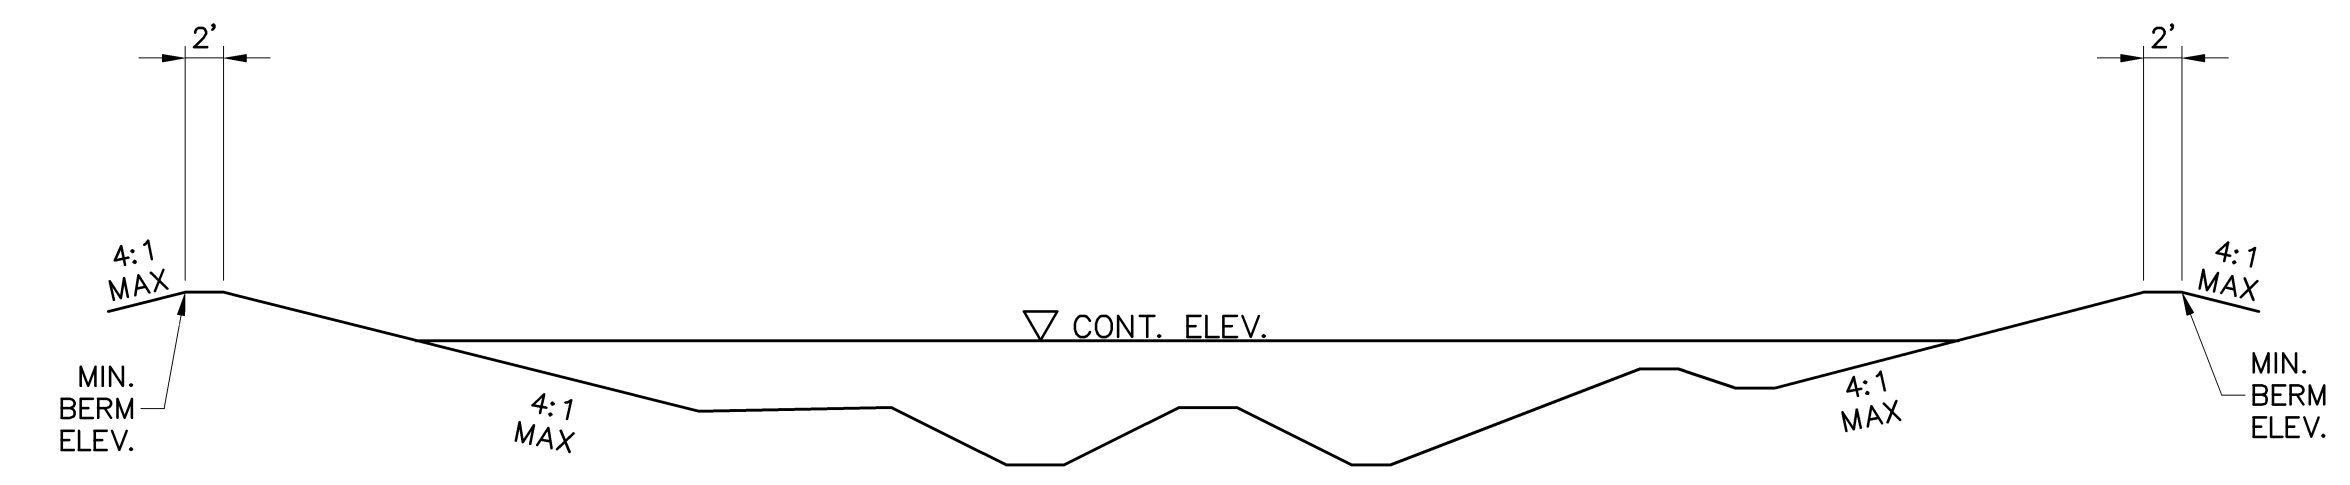

**TYPICAL TREATMENT MARSH**  
 1" = 10'

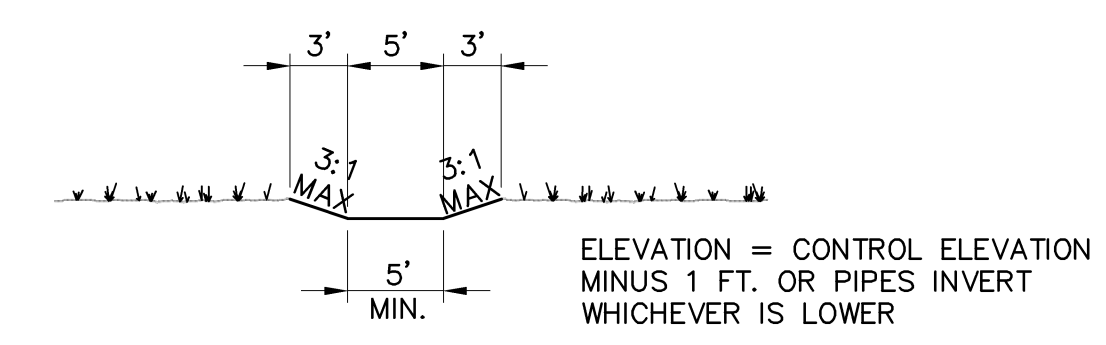

**TYPICAL SWALE**  
 1" = 10'